GENERAL NOTES

- THE SUMMARY OF WORK CONTAINED IN THESE NOTES AND SHOWN ON THE PLANS MAY NOT INCLUDE ALL ITEMS AND ACTIVITIES NECESSARY TO COMPLETE THE WORK. IN ADDITION TO THE REQUIREMENTS SHOWN IN THE DRAWINGS, TAKE MEASURES REASONABLY NECESSARY TO PROVIDE THE DESIRED WORK RESULT AND TO COMPLETE THE WORK AT NO ADDITIONAL COST TO THE OWNER.
- ASSUME SOLE AND COMPLETE RESPONSIBILITY FOR JOB SITE CONDITIONS, INCLUDING SAFETY, AND PROTECTION OF PROPERTY AND PEDESTRIANS. PROVIDE AND MAINTAIN SAFETY DEVICES IN COMPLIANCE WITH LOCAL, STATE, AND FEDERAL SAFETY AND HEALTH STANDARDS, LAWS, AND REGULATIONS.
- 3. DO NOT SCALE DRAWINGS. CONTRACTOR SHALL FIELD VERIFY ALL DIMENSIONS. DIMENSIONS SHOWN ON DRAWINGS ARE BASED UPON LIMITED FIELD VERIFICATION. AND HAVE NOT BEEN COMPLETELY FIELD VERIFIED. THE OWNER AND ENGINEER TAKE NO RESPONSIBILITY FOR THE ACCURACY OF EXISTING DIMENSIONS SHOWN ON THE DRAWINGS
- 4. NOTIFY THE OWNER AND ENGINEER OF ANTICIPATED CHANGES OR ADDITIONS TO THE WORK PRIOR TO THE START OF ACTIVITIES. GENERAL LIMITS OF THE WORK ARE NOTED ON THE PROJECT DRAWINGS WITH WORK BOUNDARIES TO BE DETERMINED IN THE FIELD B THE CONTRACTOR AND APPROVED BY THE ENGINEER.
- PROMPTLY REPORT UNANTICIPATED CONDITIONS UNCOVERED THAT ARE CONTRARY TO THE DRAWINGS OR WILL ADVERSELY IMPAC THE WORK TO THE OWNER AND ENGINEER FOR ADVISEMENT
- PROVIDE TEMPORARY PROTECTION, BARRICADES, TEMPORARY STRUCTURES, AND OTHER MEASURES AS NEEDED TO PROTECT TH PEDESTRIAN AND VEHICULAR TRAFFIC ADJACENT TO AND IN THE VICINITY OF THE WORK AREA
- . PROVIDE TEMPORARY PROTECTION WATERPROOFING, TIE-INS, WATER BLOCKS, AND INTERIOR PROTECTION AS NEEDED DURING THE WORK TO PREVENT LEAKAGE INTO THE BUILDING AND WATER DAMAGE TO THE INTERIOR. PROVIDE TARPAULINS OR PLASTIC SHEETING FOR TEMPORARY PROTECTION INSIDE THE BUILDING AS NEEDED DURING CONSTRUCTION.
- PROVIDE TEMPORARY PROTECTION OF EXISTING EQUIPMENT DURING THE WORK, SATISFYING OWNER'S REQUIREMENTS. RESTORE EXISTING EQUIPMENT, BUILDING COMPONENTS, SIDEWALK, AND GROUNDS DAMAGED DURING THIS WORK TO ORIGINAL CONDITION OR REPLACE WITH NEW MATERIALS AS DIRECTED BY THE OWNER. DAMAGED EOUIPMENT/COMPONENTS WILL BE REPLACED AT NO COST TO THE OWNER.
- 9. FOLLOW MANUFACTURER'S RECOMMENDATIONS FOR DELIVERY, STORAGE, MIXING, SURFACE PREPARATION, APPLICATION, AND CURING OF MATERIALS USED FOR RESTORATION WORK.
- SECURE SITE STAGING AREA FOR STORAGE TO BE COORDINATED WITH OWNER PRIOR TO BEGINNING WORK
- 11. STORAGE OF MATERIALS INSIDE THE BUILDING IS PROHIBITED. DO NOT STORE FLAMMABLE MATERIALS ON THE ROOFS OR IN THE STAGING AREA. REMOVE FLAMMABLE MATERIALS FROM THE SITE AND SECURELY STORE THEM AT THE END OF EACH WORK DAY. 12. TAKE DUE CARE AND CAUTION TO AVOID TRACKING DUST, DEBRIS, OR LOOSE MATERIALS TO AREAS OUTSIDE OF THE CONSTRUCTION AREA. REMOVE MATERIALS TRACKED TO AREAS OUTSIDE OF THE CONSTRUCTION AREA AS SOON AS POSSIBLE. AT NO ADDITIONAL COS TO THE OWNER. CONDUCT AN INSPECTION AT THE END OF EACH WORK DAY OF THE PROJECT AREA AND TAKE STEPS TO ENSURE THAT THE ENTIRE WORK AREA IS CLEAN. THIS REQUIREMENT INCLUDES DEBRIS FROM THE CONTRACTOR'S EMPLOYEES EATING LUNCH OR OF BREAKS.
- 13. REMOVE WASTE MATERIALS AND DEBRIS RESULTING FROM THE WORK FROM THE SITE AND DISPOSE OF IN A LEGAL MANNE 14. REMOVE STAINING/CONTAMINANTS FROM BUILDING SURFACES AND THE GROUNDS, INCLUDING SPILLED OR SMEARED SEALANTS, BITUMINOUS MATERIALS, GASOLINE AND FUEL SPILLS, AND HYDRAULIC LEAKAGE FROM THE EQUIPMENT USED ONSITE.
- 15. PROVIDE PROTECTION OF SIDEWALKS OR OTHER PAVEMENTS AGAINST BREAKAGE DUE TO MANLIFT USE OR OTHER EQUIPMENT. RESTORE DAMAGED SIDEWALKS AND PAVEMENTS TO PRE-PROJECT CONDITIONS.
- 16. MAINTAIN UP-TO-DATE SET OF PROJECT DOCUMENTS AT THE JOB-SITE. KEEP ACCURATE AND LEGIBLE RECORDS OF CHANGES TO THE WORK THAT OCCUR DURING CONSTRUCTION AND INFORMATION ON 'AS-BUILT' EXISTING OR CONSTRUCTED CONDITIONS. KEEP RECORDS OF CHANGES AND AS-BUILT CONDITIONS DOCUMENTED ON A SET OF DRAWINGS TO BE PROVIDED TO THE ENGINEER AT CONSTRUCTION COMPLETION.
- 17. UPON COMPLETION OF THE WORK, CLEAR THE ENTIRE SITE OF EQUIPMENT, UNUSED MATERIALS, AND RUBBISH. RESTORE DISTURBED AREAS TO THE SATISFACTION OF THE OWNER.

SCOPE OF WORK:


- 1. REMOVE AND REPLACE ROOFING ASSEMBLY ON EACH ROOF WITH NEW FULLY ADHERED, BLACK, 60-MIL EPDM MEMBRANE, INSULATION, PERIMETER FLASHINGS, EDGE METAL FLASHINGS, 20-YEAR ROOFING MANUFACTURER'S WARRANTY, AND 2-YEAR CONTRACTOR'S WARRANTY. EDGE METAL TO BE INCLUDED IN ROOFING MANUFACTURER'S 20-YEAR WARRANTY.
- 2. REPLACE EACH DRAIN AS INDICATED ON PROJECT DRAWINGS AND SPECIFICATIONS.
- 3. REPLACE DETERIORATED WOOD BLOCKING TO MATCH EXISTING TYPE AND THICKNESS.
- 4. ADD WOOD BLOCKING ON CURBS AND PERIMETERS TO ACCOMMODATE NEW INSULATION HEIGHTS. IT IS THE CONTRACTOR'S
- RESPONSIBILITY TO VERIFY THE NUMBER OF NAILERS REQUIRED TO PROVIDE A MINIMUM OF 8-INCHES FLASHING HEIGHT. 5. PROVIDE LICENSED ELECTRICAL, PLUMBING, OR HVAC SUBCONTRACTORS TO DISCONNECT AND RECONNECT MECHANICAL UNITS, ADJUST OR RELOCATE UTILITIES, RAISE CURBS, ABANDON DESIGNATED CURBS, RAISE DUCTWORK, INSTALL NEW DRAINS OR SCUPPER COMPONENTS, AND ABANDON DESIGNATED DRAINS AND PIPING. IN-PLACE SYSTEMS SHALL ACCOMMODATE NEW INSULATION THICKNESSES AND MEET WARRANTY REQUIREMENTS FOR FLASH HEIGHT BY ROOFING MANUFACTURER.
 - a. ALL MECHANICAL UNITS AND UTILITIES MUST BE OPERATIONAL AND DRAINS FREE-FLOWING AT THE COMPLETION OF THE PROJECT. THIS INCLUDES CONDUITS DAMAGED BY SCREWS OR OTHER ITEMS THAT MAY DAMAGE UTILITIES.
 - b. WORK TO BE COMPLETED IN ACCORDANCE WITH LOCAL CODES AND JURISDICTION(S) OF AUTHORITY. DO NOT SHUT OFF OR INHIBIT UTILITY SERVICES WITHOUT NOTIFYING OWNER'S REPRESENTATIVE IN ADVANCE.

SYMBOL AND ABBREVIATION INDEX

PARTIAL SECTION INDICATOR TYPICAL


(#	
$\overline{\zeta}$	A4.1	ノ

A4.1					
ACC ADDL ADH ADJ ADMIN AISC ALT ANSI APPX REQD ASYM BLDG BLW BOT BTWN € CG CTRL DEMO DIA DIM DWG EL ELEM ENCL	ACCESSIBLE ADDITIONAL ADHESIVE ADJACENT ADMINISTRATION AMERICAN INSTITUTE OF STEEL CONSTRUCTION ALTERNATE AMERICAN NATIONAL STANDARD INSTITUTE APPENDIX REQUIRED ASYMMETRICAL BUILDING BELOW BOTTOM BETWEEN CENTER LINE CENTER OF GRAVITY CONTROL DEMOLITION DIAMETER DIMENSION DRAWING ELEVATION ELEMENT ENCLOSURE	EQ EQL SP EQUIP EXT FIG GA GL GR LN GRAD IBC INT KIP KLF LBF LIN LYR MAT MBR MFR NBC OC OPNG OPP	EQUAL EQUALLY SPACED EQUIPMENT EXTERNAL/EXTERIOR FIGURE FEET GAUGE GROUND LEVEL GRADE LINE GRADIENT INTERNATIONAL BUILDING CODE INTERIOR THOUSAND POUNDS KIP PER LINEAR FOOT POUND FORCE LINEAR LINE LAYER MATERIAL MEMBER MANUFACTURER NATIONAL BUILDING CODE ON CENTER OPENING OPPOSITE	OPT PROJ QTY SIM STD SYMM SYS TYP UNO VIF	OPTIONAL PROJECT QUANTITY SIMILAR STANDARD SYMMETRICAL SYSTEM TYPICAL UNLESS NOTED OTHERWISE VERIFY IN FIELD

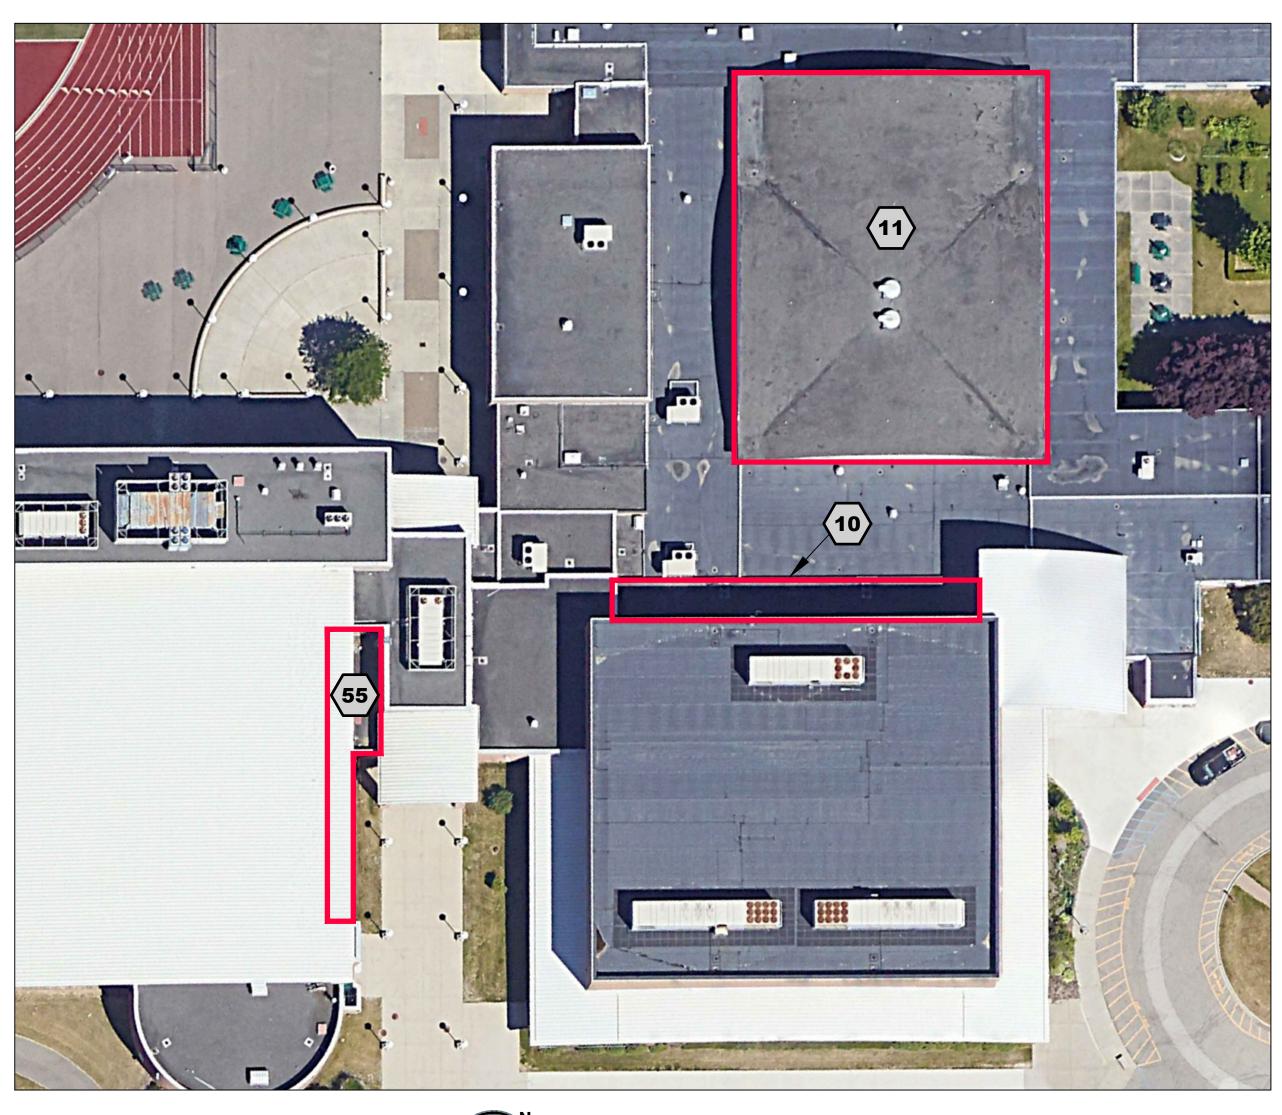


2024 Waterford School District Kettering High School Roofing Replacement 2800 Kettering Drive Waterford Twp., Michigan 48329



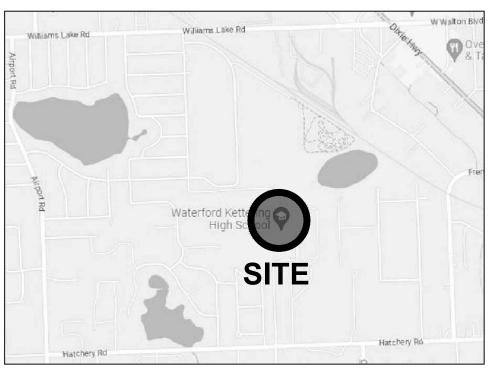





		Proje 20 DIS	ntation ect 024 W/ STRIC		.com	OOL
ENGINE				NG HIGH G REPLAC		
SME 43980 PLYMO	UTH OAKS BLVD.					
PLYMOUTH, N CONTACT: KYI PHONE: 734-4	LE DAMEROW, PE	Proie	ect Locatio	n		
	DAMEROW@SME-USA.COM			TTERING	DR.,	
WATERFORD S 501 N. CASS L WATERFORD,	MICHIGAN 48328 ESENTATIVE: MR. SIDNEY TIPPETT	W	ATERF	ORD TWF	P., MI 4	8329
	01@WSDMI.ORG		et Name	SHEET		
2015 MICI	BLE CODES HIGAN REHAB CODE					
SHEET NO.	SHEET TITLE	Seal	l			
G0.1	COVER SHEET					
G1.1 G1.2	ROOF AREA 10 WIND DESIGN LOADING / ZONE PLAN ROOF AREA 11 WIND DESIGN LOADING / ZONE PLAN					
G1.3	ROOF AREA 55 WIND DESIGN LOADING / ZONE PLAN					
A1.1 A1.2	ROOF PLAN AREA 10 ROOF PLAN AREA 11					
A1.3	ROOF PLAN AREA 55	Revi	sions			
A4.1 A4.2	FLASHING DETAILS FLASHING DETAILS	REV	ISSUED I OWNER I BIDS		DATE 12-22-23 1-16-24	BY KMD KMD
		SME	Project No).		
			a et 14	094776.0	0	
		Proje	ect Manag	er: KMD		
		Desi	gner:	KMD		
		CAD	D:			
		Cheo	cked By:	GUS KMD		
		Revi	ewed By:			
		Shee	et No.			
				G0.1		
			v	WING NOTE: SCALE DEPICTED IS VILL SCALE INCORRECTLY IF PRIN MEDIA 10 REPRODUCTION SHALL BE MAI CONSENT OF S © 2023	ED ON ANY OTHER SIZ	Έ .

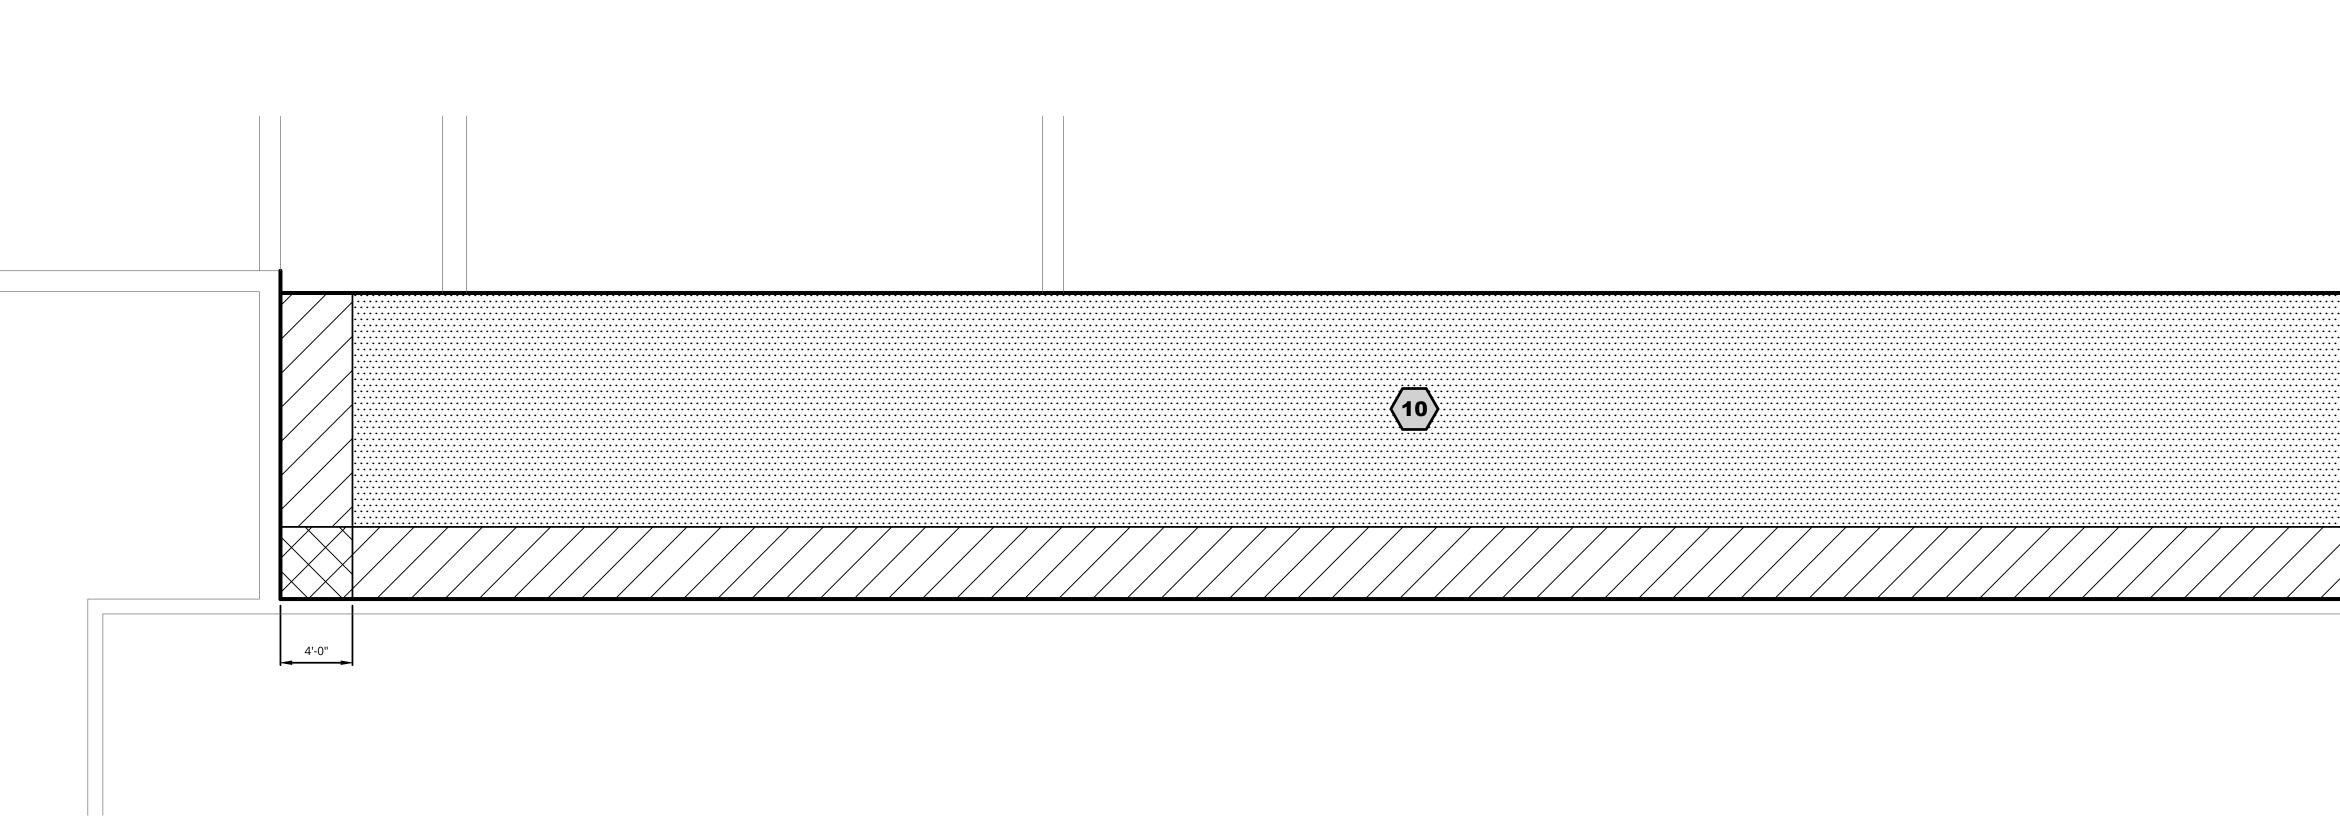



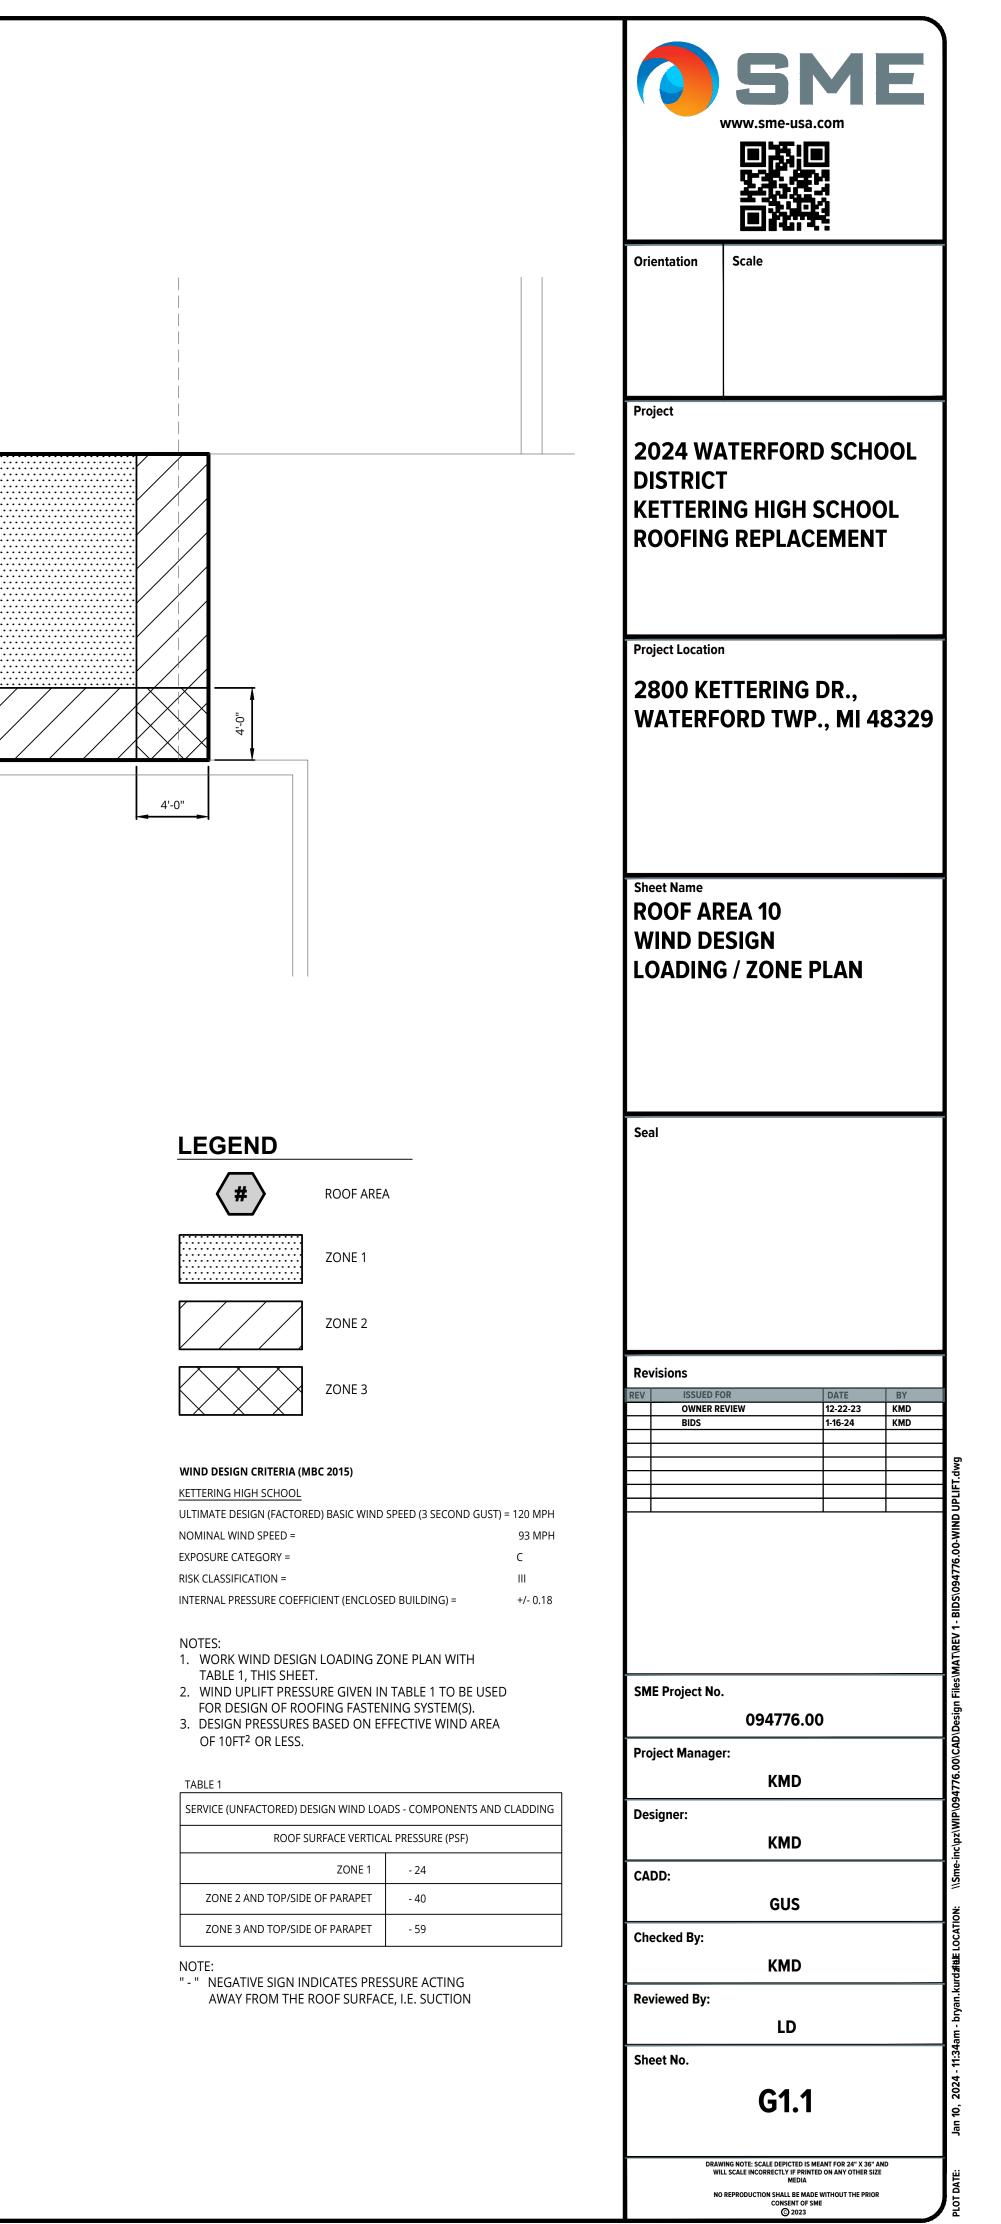

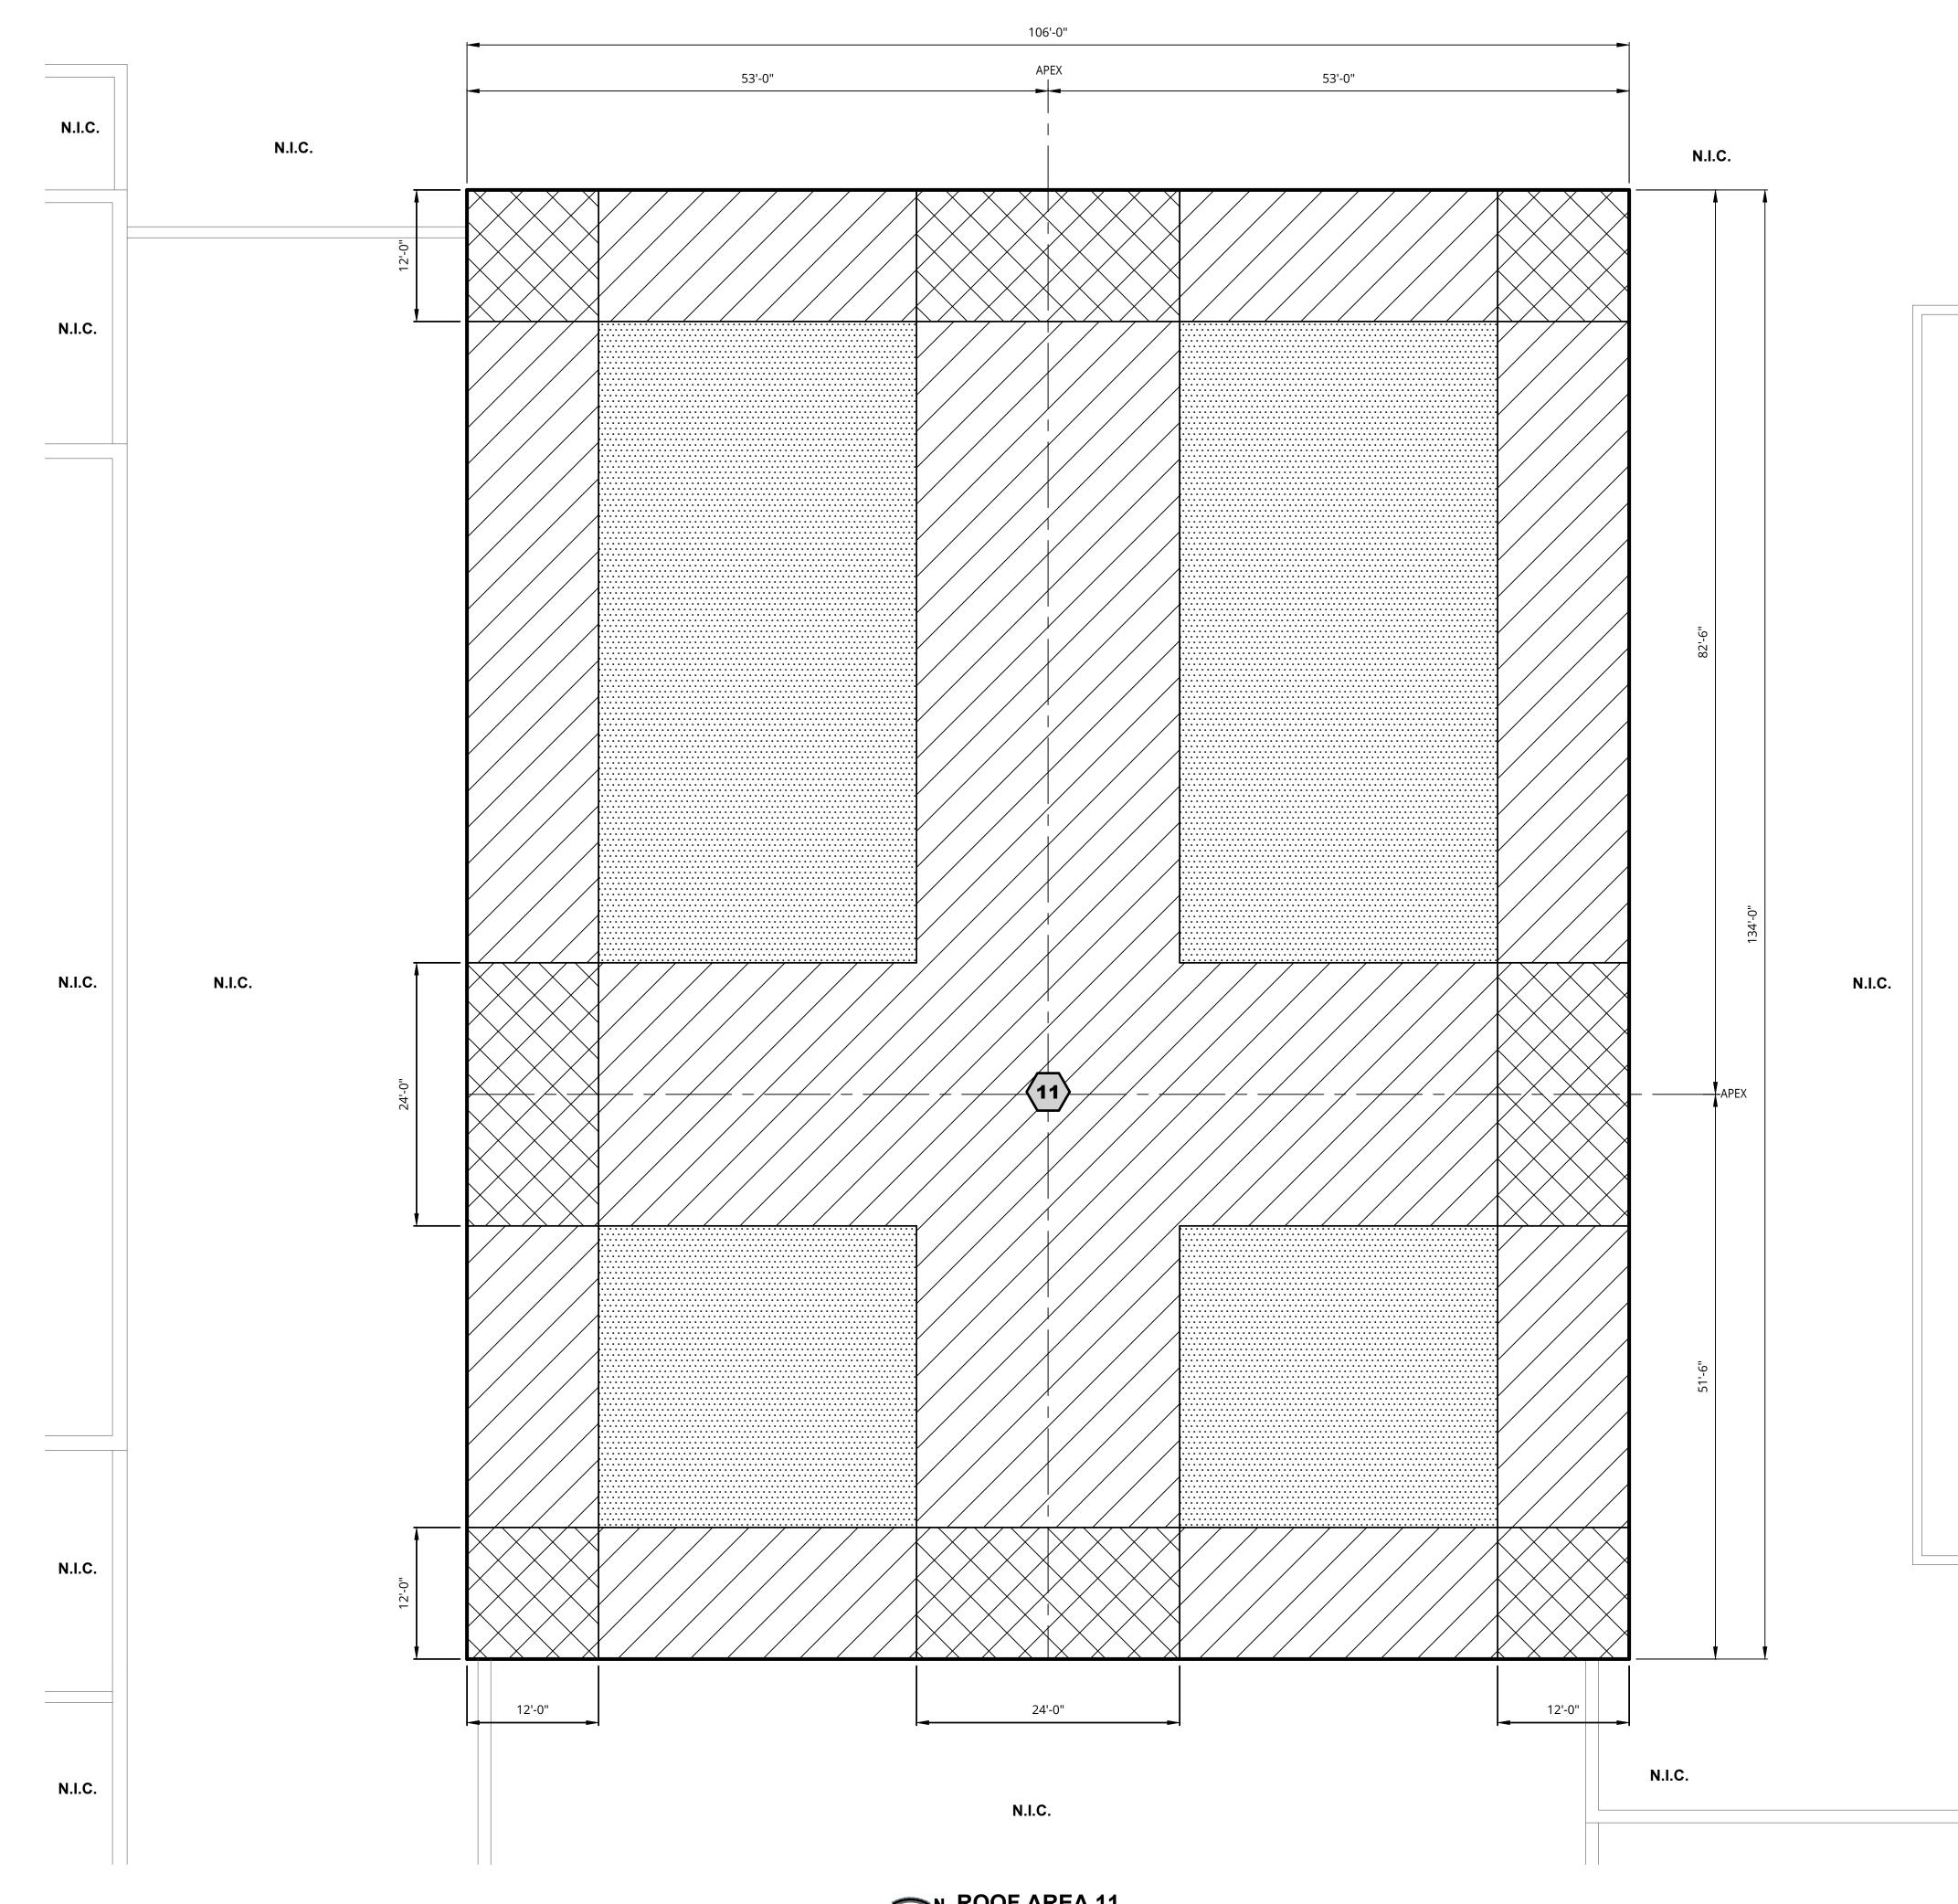


N ROOF AREA 11 WIND DESIGN LOADING / ZONE PLAN SCALE: 1/8" = 1'-0"

				www.sm	e-usa.com	Ε
			DIS1 KET	4 WATERF RICT TERING HI OFING REP	GH SCHO	OL
			280	Location O KETTERI ERFORD 1		48329
			WIN	Iame OF AREA 11 D DESIGN DING / ZOI		
LEGEND ROOF ARE ZONE 1 ZONE 2	 A		Seal			
			Revisio	ns		
ZONE 3			REV	ISSUED FOR OWNER REVIEW	DATE 12-22-23	BY KMD
				BIDS	1-16-24	
MIND DESIGN CRITERIA (MBC 2015) <u>XETTERING HIGH SCHOOL</u> JLTIMATE DESIGN (FACTORED) BASIC WIND NOMINAL WIND SPEED = EXPOSURE CATEGORY = RISK CLASSIFICATION = NTERNAL PRESSURE COEFFICIENT (ENCLOSE NOTES: 1. WORK WIND DESIGN LOADING ZO TABLE 1, THIS SHEET. 2. WIND UPLIFT PRESSURE GIVEN IN FOR DESIGN OF ROOFING FASTEN 3. DESIGN PRESSURES BASED ON EF OF 10FT ² OR LESS.	ED BUILDING) = ONE PLAN WITH I TABLE 1 TO BE USED NING SYSTEM(S).	93 MPH C III +/- 0.18		oject No. 0947 Manager:	776.00	
TABLE 1				К	MD	
SERVICE (UNFACTORED) DESIGN WIND LOA ROOF SURFACE VERTICA		CLADDING	Designe			
ZONE 1	- 24		CADD:	K	MD	li Cmo i incluzi
ZONE 2 AND TOP/SIDE OF PARAPET	- 40 - 59				US	
]	Checke		MD	
NOTE: - " NEGATIVE SIGN INDICATES PRES AWAY FROM THE ROOF SURFAC			Review	ed By:		
			Sheet N	lo.	1.2	lan 10 2024 - 11:32am - houan kurd48E LOCATON.
				WILL SCALE INCORREC	EPICTED IS MEANT FOR 24" X 36 TLY IF PRINTED ON ANY OTHER S MEDIA ALL BE MADE WITHOUT THE PRIG INSENT OF SME @ 2023	IZE

COURT


N.I.C.

SERVICE (UNFACTORED) DESIGN WIND LOADS - COMPONENTS AND CLADDING				
ROOF SURFACE VERTICAL PRESSURE (PSF)				
ZONE 1	- 24			
ZONE 2 AND TOP/SIDE OF PARAPET	- 40			
ZONE 3 AND TOP/SIDE OF PARAPET	- 59			

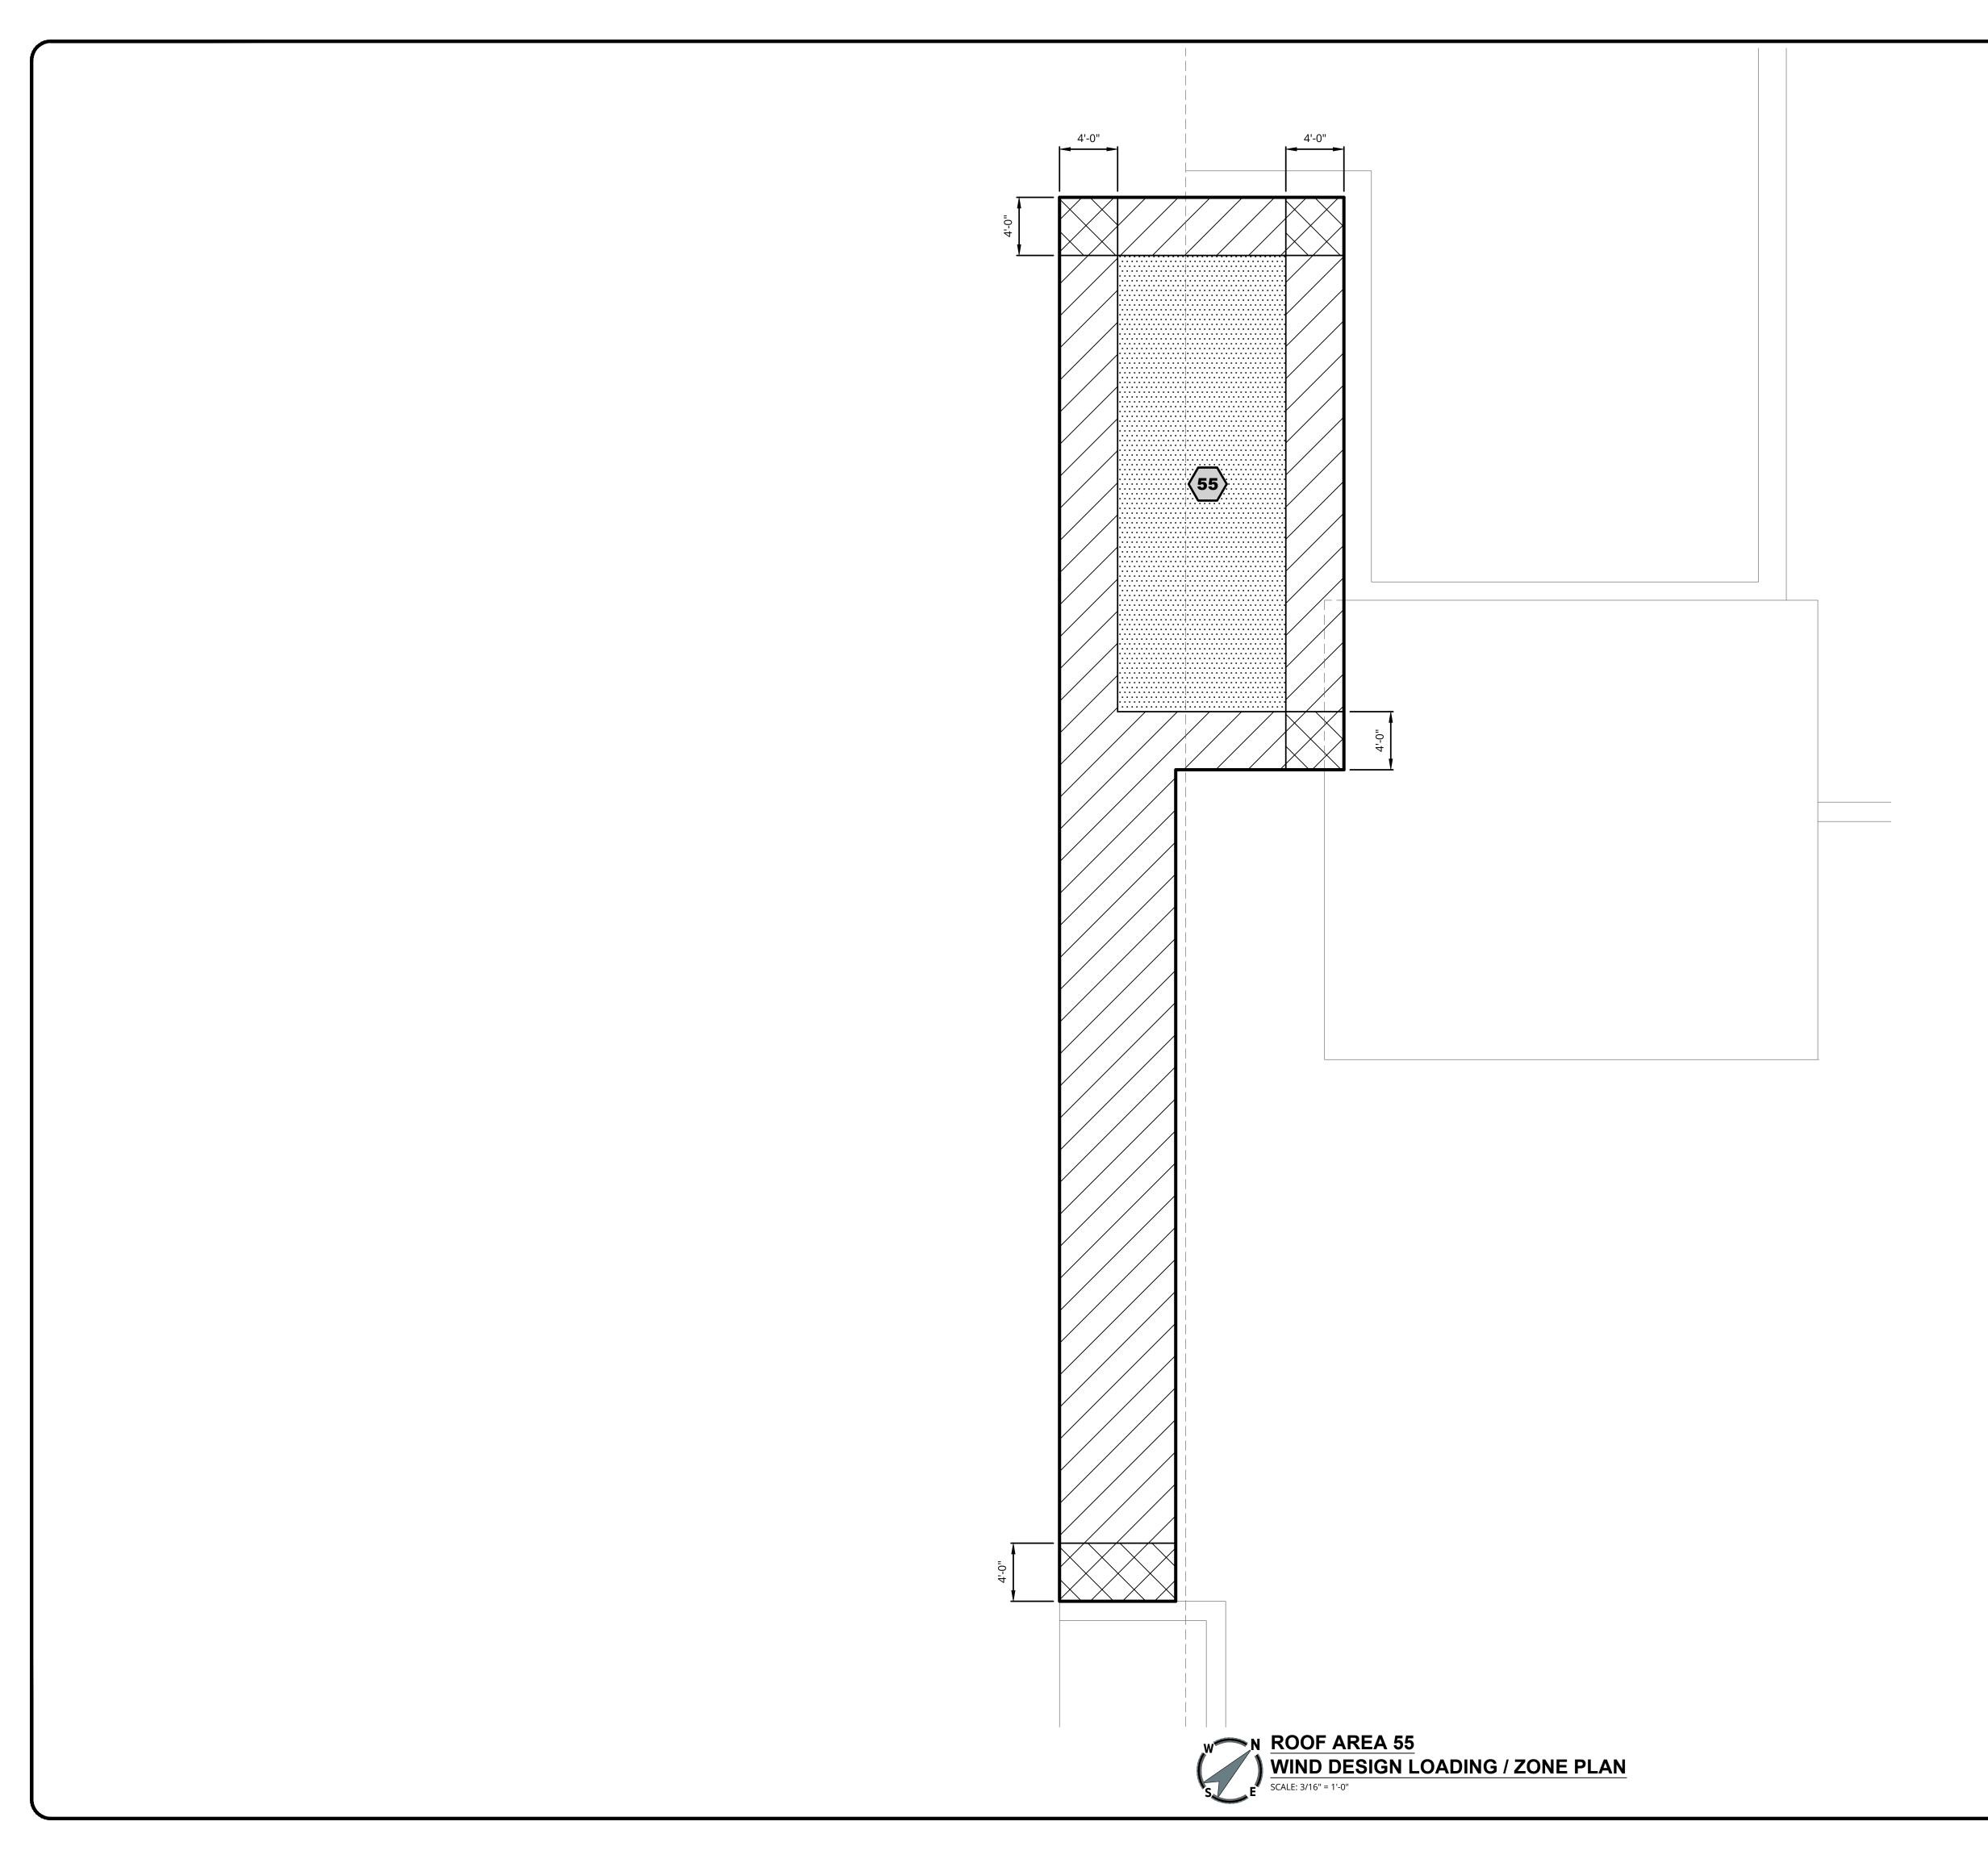

		SSR www.sme-usa.c	com	Ε	
Or	ientation	Scale			
2 D K	ISTRICI ETTERII	ATERFORD NG HIGH S S REPLACI	снос	L	
2		TTERING I ORD TWP.	-	8329	
R W	Sheet Name ROOF AREA 55 WIND DESIGN LOADING / ZONE PLAN				
Se	al				
	visions	DR	DATE	RY	
Re	VISIONS ISSUED FO OWNER RI BIDS		DATE 12-22-23 1-16-24	BY KMD KMD	
	ISSUED FO		12-22-23	KMD	
	ISSUED FO		12-22-23	KMD	
SM	ISSUED FO OWNER RI BIDS	<u>VIEW</u>	12-22-23	KMD	
REV	ISSUED PO OWNER RI BIDS	<u>VIEW</u>	12-22-23	KMD	
REV	ISSUED PO OWNER RI BIDS	EVIEW	12-22-23	KMD	
REV	ISSUED PO OWNER RI BIDS	т: КМD	12-22-23	KMD	
REV	ISSUED PO OWNER RI BIDS	EVIEW 094776.00 r: KMD	12-22-23	KMD	
REV	ISSUED PO OWNER RI BIDS	eview 094776.00 r: KMD KMD GUS	12-22-23	KMD	
REV	ISSUED PO OWNER RI BIDS	EVIEW O94776.00 r: KMD GUS KMD	12-22-23	KMD	

LEGEND

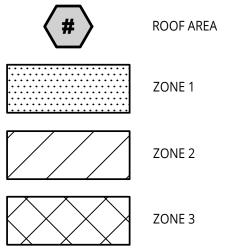

ZONE 1

ZONE 2

WIND DESIGN CRITERIA (MBC 2015)

KETTERING HIGH SCHOOL

ULTIMATE DESIGN (FACTORED) BASIC WIND SPEED (3 SECOND GUST) = 120 MPH 93 MPH NOMINAL WIND SPEED = EXPOSURE CATEGORY = С RISK CLASSIFICATION = |||

INTERNAL PRESSURE COEFFICIENT (ENCLOSED BUILDING) =	+/- 0.18

NOTES:

- WORK WIND DESIGN LOADING ZONE PLAN WITH TABLE 1, THIS SHEET.
 WIND UPLIFT PRESSURE GIVEN IN TABLE 1 TO BE USED FOR DESIGN OF ROOFING FASTENING SYSTEM(S).
 DESIGN PRESSURES BASED ON EFFECTIVE WIND AREA DESIGN PRESSURES BASED ON EFFECTIVE WIND AREA
- OF 10FT² OR LESS.


TABLE 1

SERVICE (UNFACTORED) DESIGN WIND LOADS - COMPONENTS AND CLADDING ROOF SURFACE VERTICAL PRESSURE (PSF)


ZONE 1	- 24
ZONE 2 AND TOP/SIDE OF PARAPET	- 40
ZONE 3 AND TOP/SIDE OF PARAPET	- 59


NOTE:

" - " NEGATIVE SIGN INDICATES PRESSURE ACTING AWAY FROM THE ROOF SURFACE, I.E. SUCTION

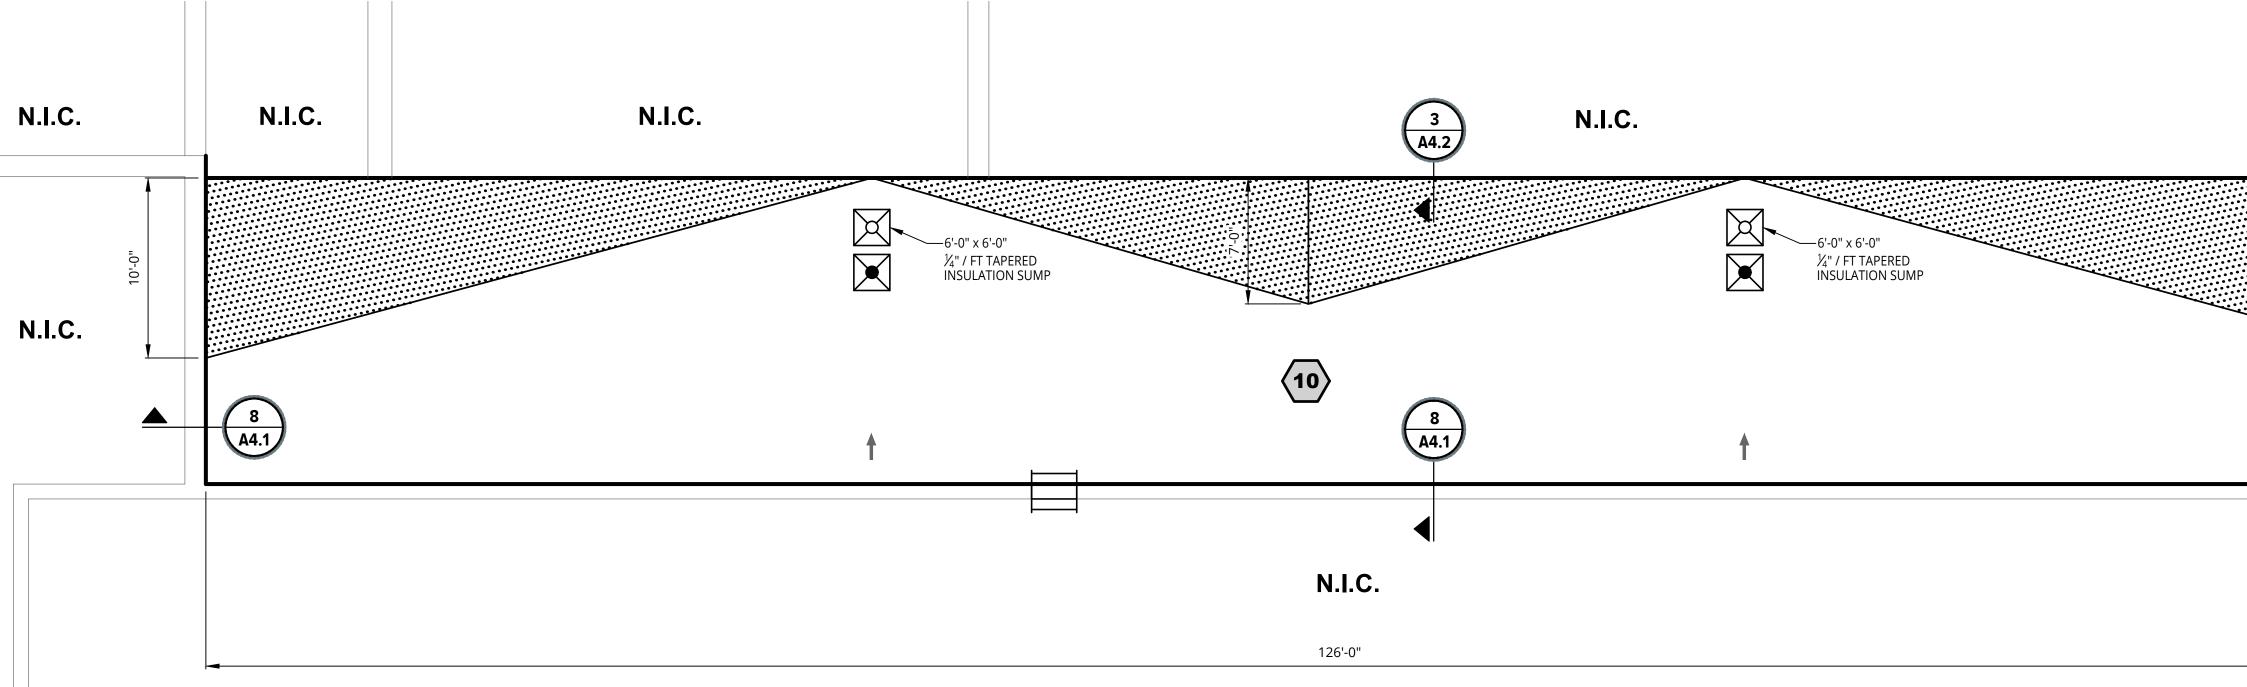



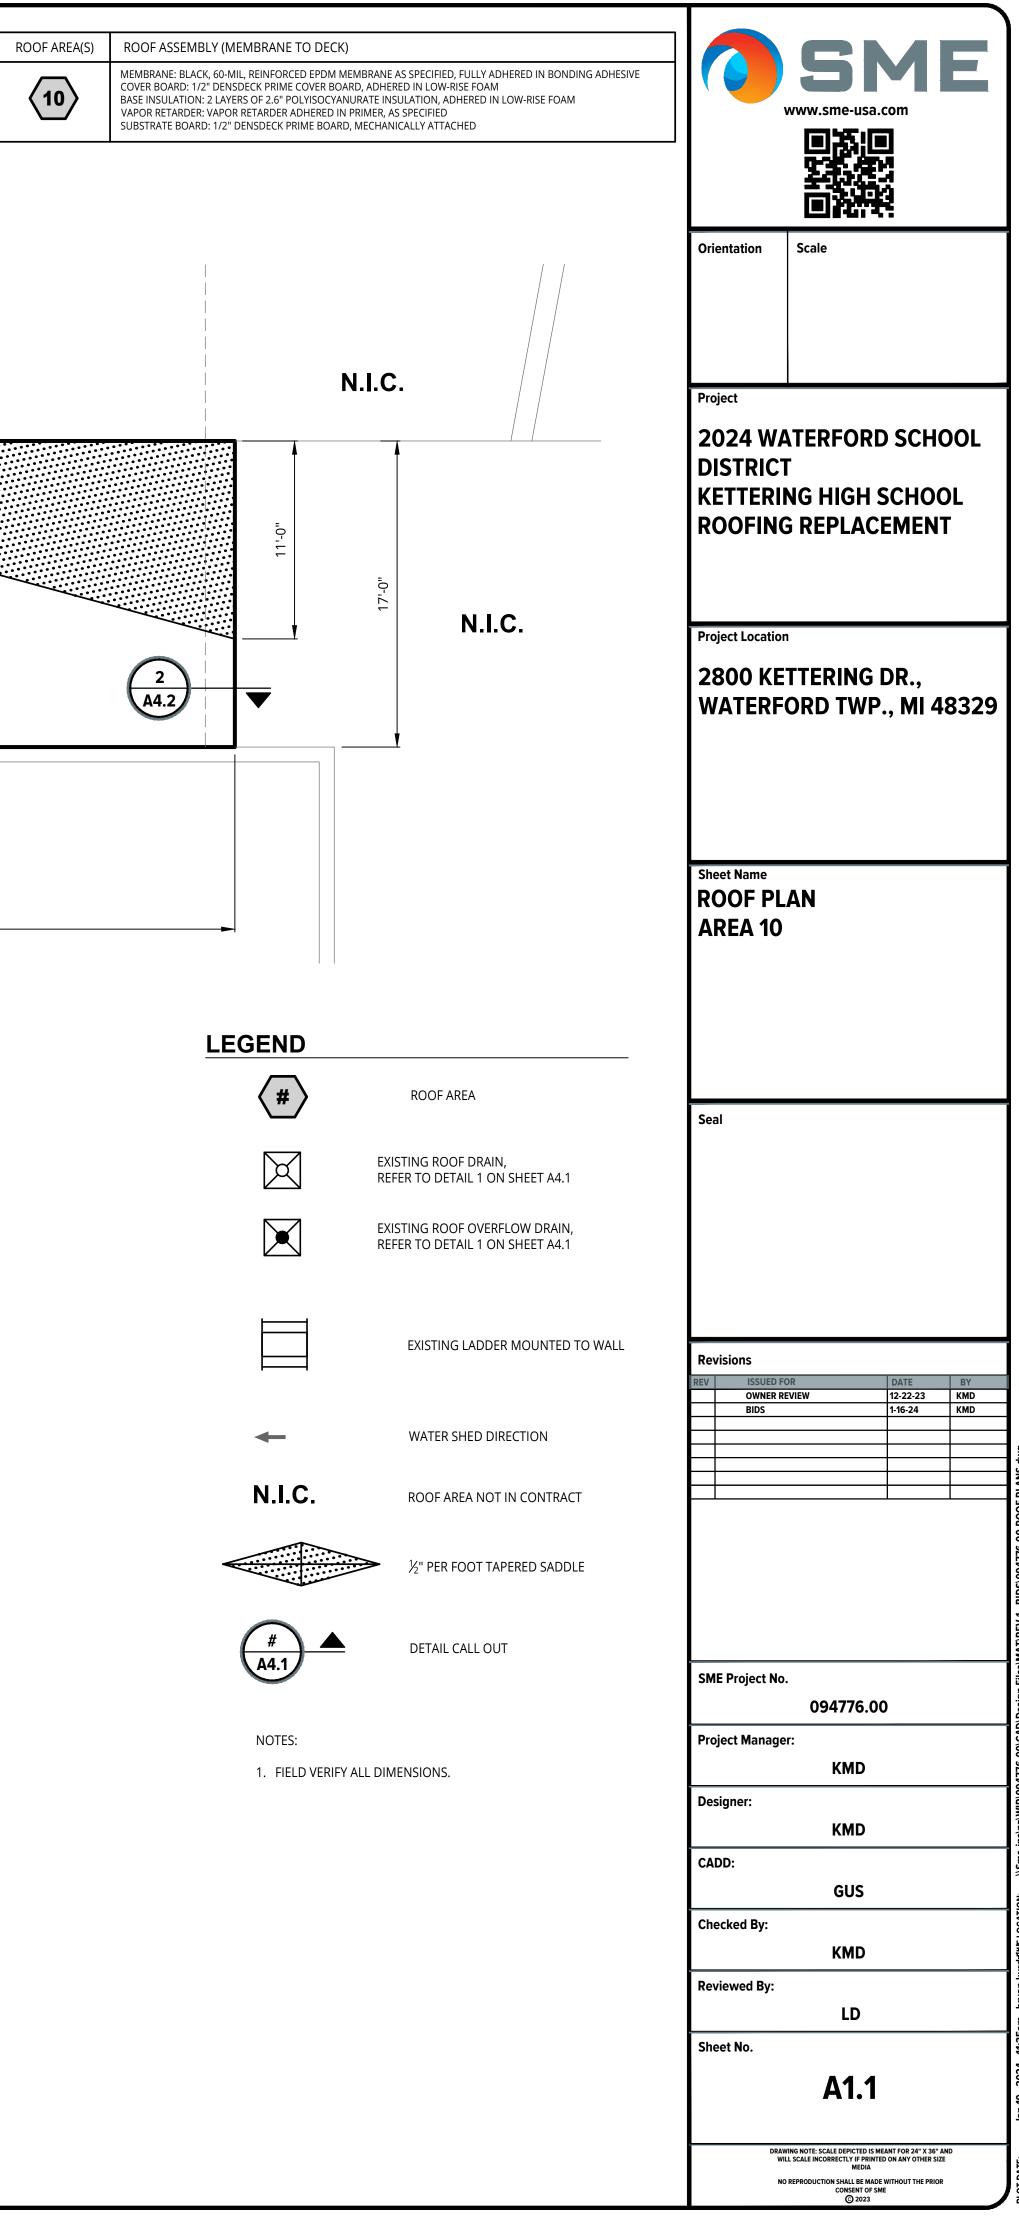

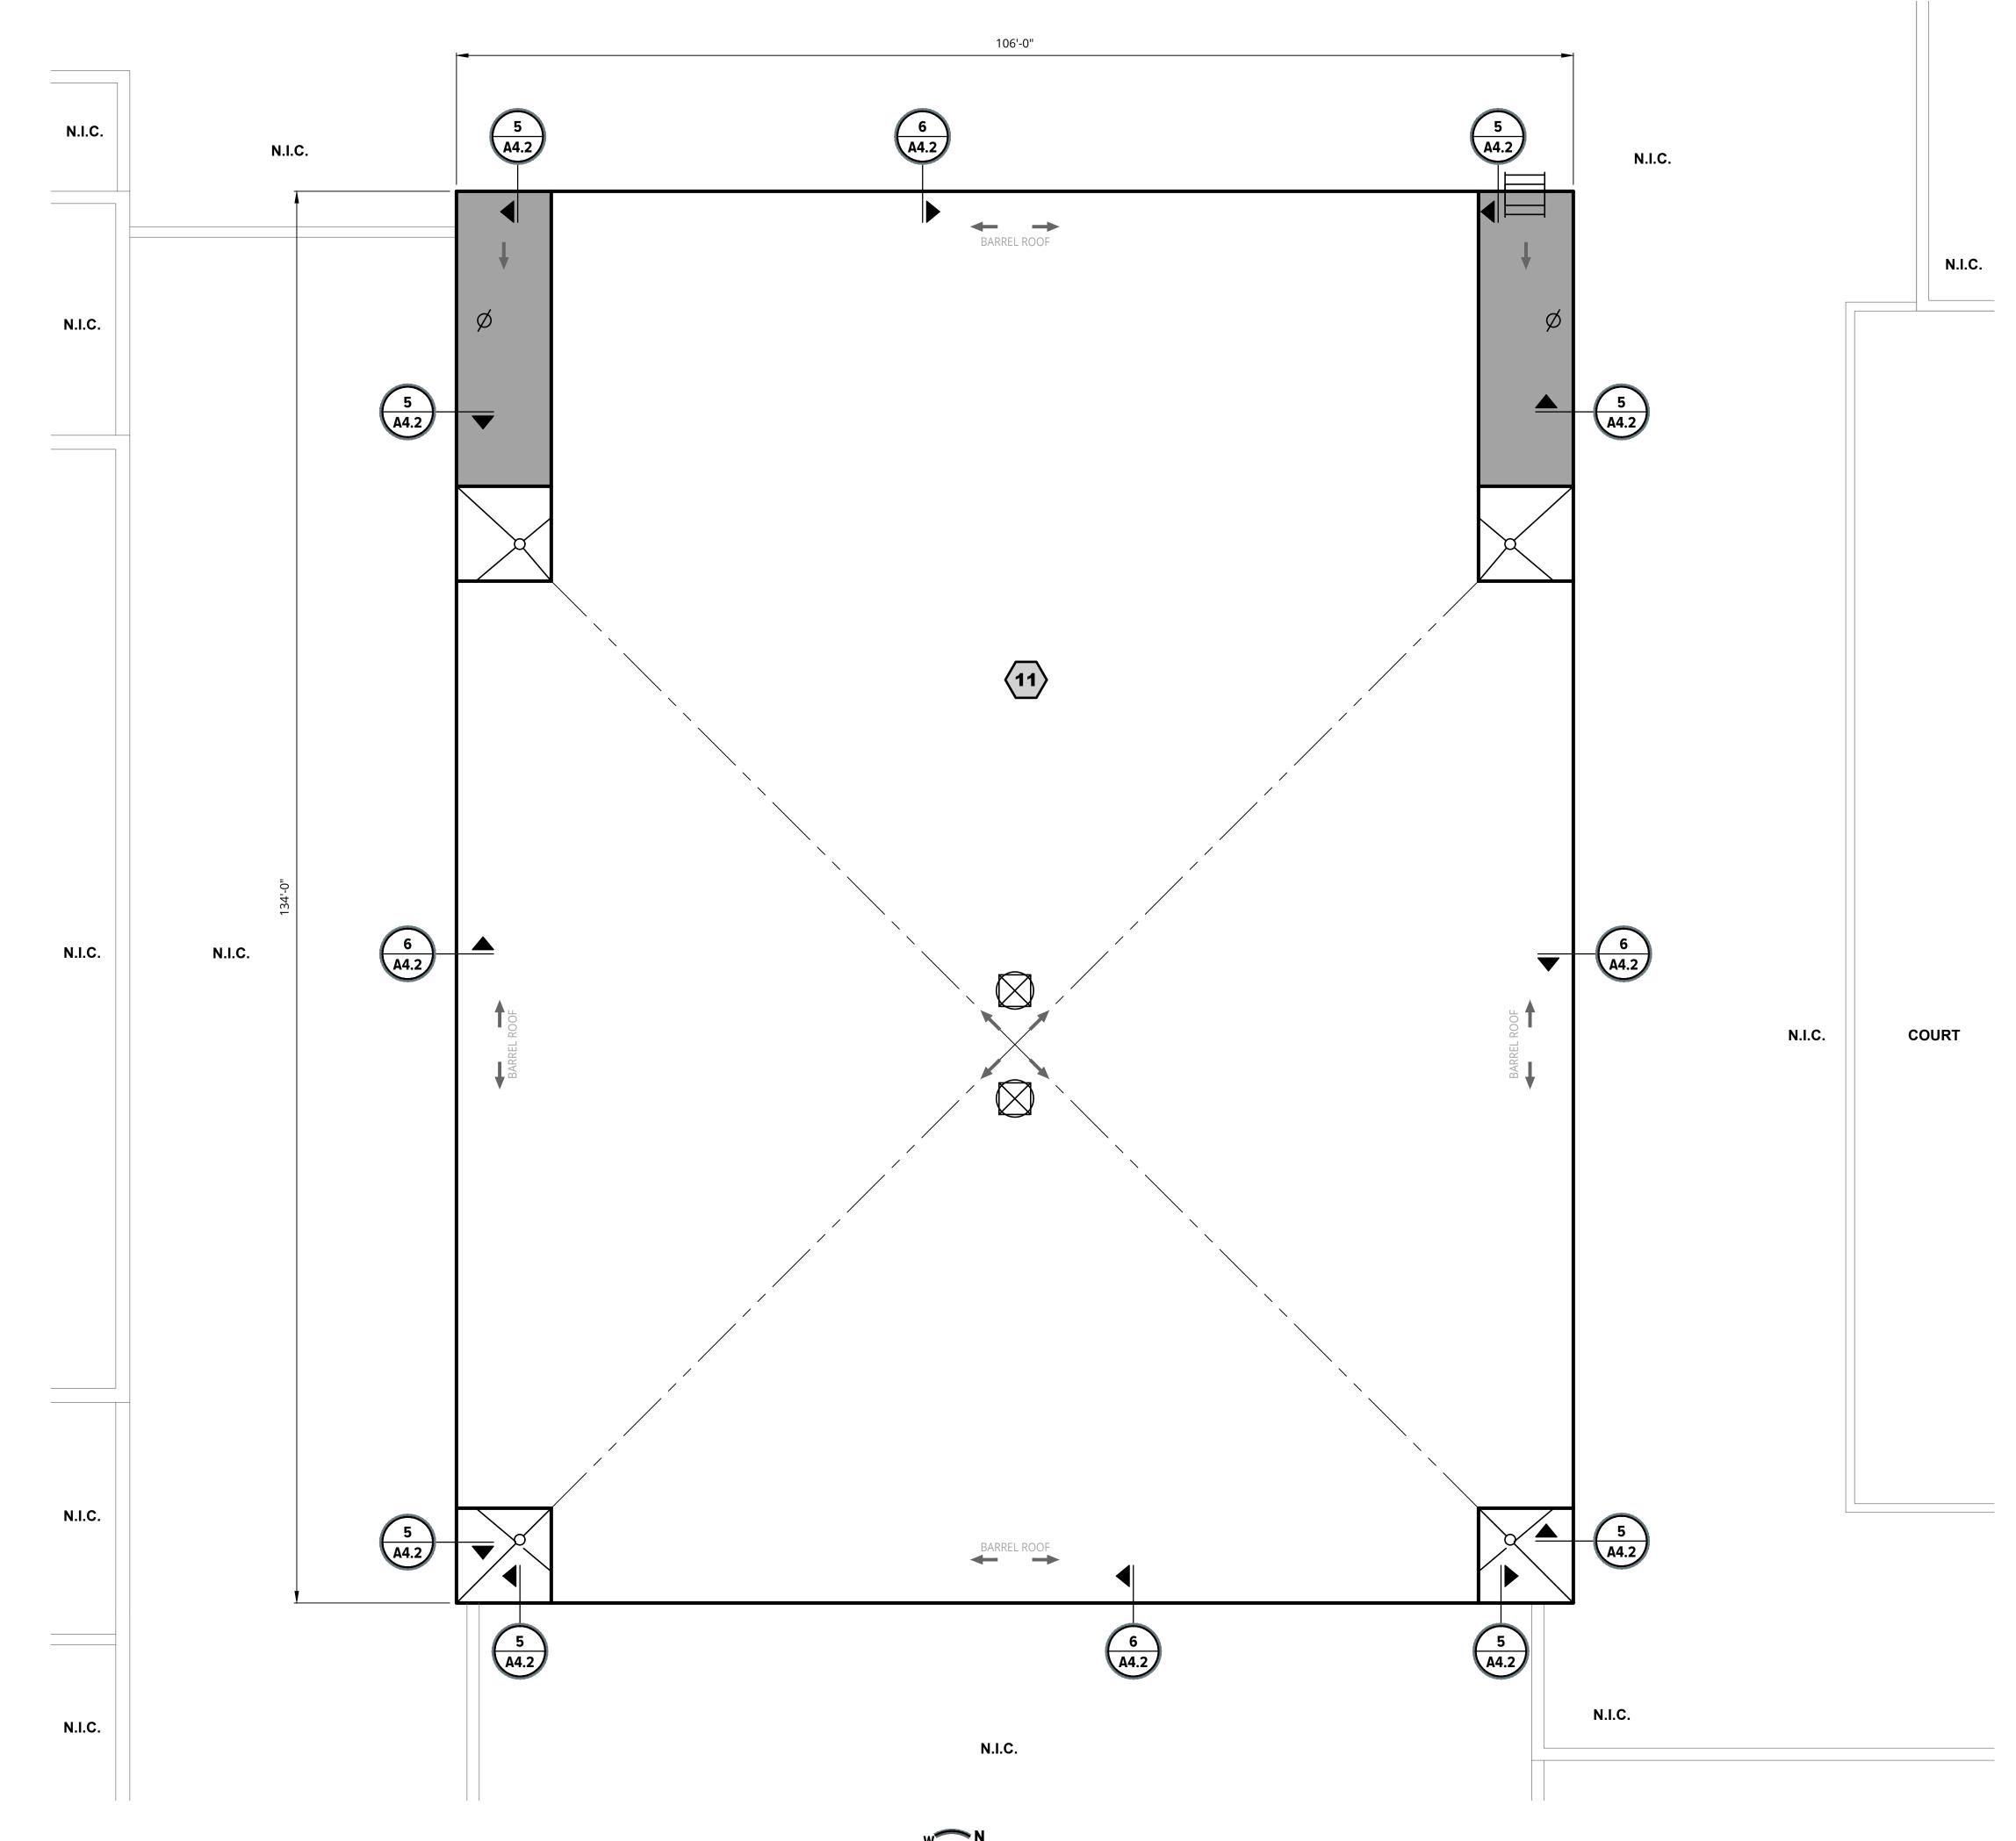





ROOF	AREA(S	


(11)

ROOF ASSEMBLY (MEMBRANE TO DECK)

MEMBRANE: BLACK, 60-MIL, UNREINFORCED EPDM MEMBRANE AS SPECIFIED, FULLY ADHERED IN BONDING ADHES COVER BOARD: 1/2" DENSDECK PRIME COVER BOARD, MECHANICALLY ATTACHED BASE INSULATION: 2 LAYERS OF 2.6" POLYISOCYANURATE INSULATION, MECHANICALLY ATTACHED VAPOR RETARDER: VAPOR RETARDER ADHERED IN PRIMER, AS SPECIFIED SUBSTRATE BOARD: 1/2" DENSDECK PRIME BOARD, MECHANICALLY ATTACHED

MBRANE AS SPECIFIED, FULLY ADHERED IN BONDING ADHESIVE MECHANICALLY ATTACHED TE INSULATION, MECHANICALLY ATTACHED IER, AS SPECIFIED CHANICALLY ATTACHED		www.sme-usa.	com	
	Orientation	Scale		
	DISTRIC [®] KETTERI	ATERFORE T NG HIGH S G REPLAC	SCHO	OL
		TTERING		8329
	Sheet Name ROOF PL AREA 11	AN		
ROOF AREA EXISTING ROOF DRAIN, WITH ¼" / FT 9'-0" x 9'-0" TAPERED INSULATION SUMP PER DETAIL 1 ON SHEET A4.1	Seal			
SOIL VENT PIPE, PER DETAIL 2 ON SHEET A4.1				
CURBED MOUNT POWERED VENT, PER DETAIL 3 ON SHEET A4.1	Revisions		DATE	BY
REMOVE AND REPLACE EXISTING MOUNTED LADDER WITH NEW FIXED PREFINISHED STEEL WALKTHROUGH LADDER WITH INTEGRATED HAND RAILS. SECURE TO EXISTING WALL IN ACCORDANCE WITH MANUFACTURER'S WRITTEN INSTALLATION INSTRUCTIONS. COMPLETED INSTALLATION TO BE OSHA COMPLIANT	OWNER F BIDS		12-22-23 1-16-24	KMD KMD
WATER SHED DIRECTION				
ROOF AREA NOT IN CONTRACT				
⅛" PER FOOT TAPERED SYSTEM	SME Project No	094776.00)	
DETAIL CALL OUT	Project Manage Designer:	er: KMD		
VALLEY	CADD:	KMD		
	Checked By:	GUS		
ONS.	Reviewed By:	LD		
	Sheet No.	A1.2		
		WING NOTE: SCALE DEPICTED IS ME ILL SCALE INCORRECTLY IF PRINTE MEDIA		

LEGEND

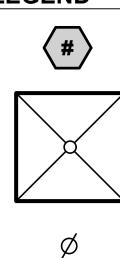





 \leftarrow

N.I.C.



_____ — _ _ VALLEY


NOTES:

1. FIELD VERIFY ALL DIMENSIONS.

NO REPRODUCTION SHALL BE MADE WITHOUT THE PRIOR CONSENT OF SME © 2023

REMOVE BOTTOM LADDER RUNG AND SIDE RAIL SECTION AS NEEDED TO ALLOW INSTALLATION OF NEW ROOFING ASSEMBLY. COAT CUT EDGES WITH GALVANIZING REPAIR PAINT. DO NOT DAMAGE LADDER

N.I.C.

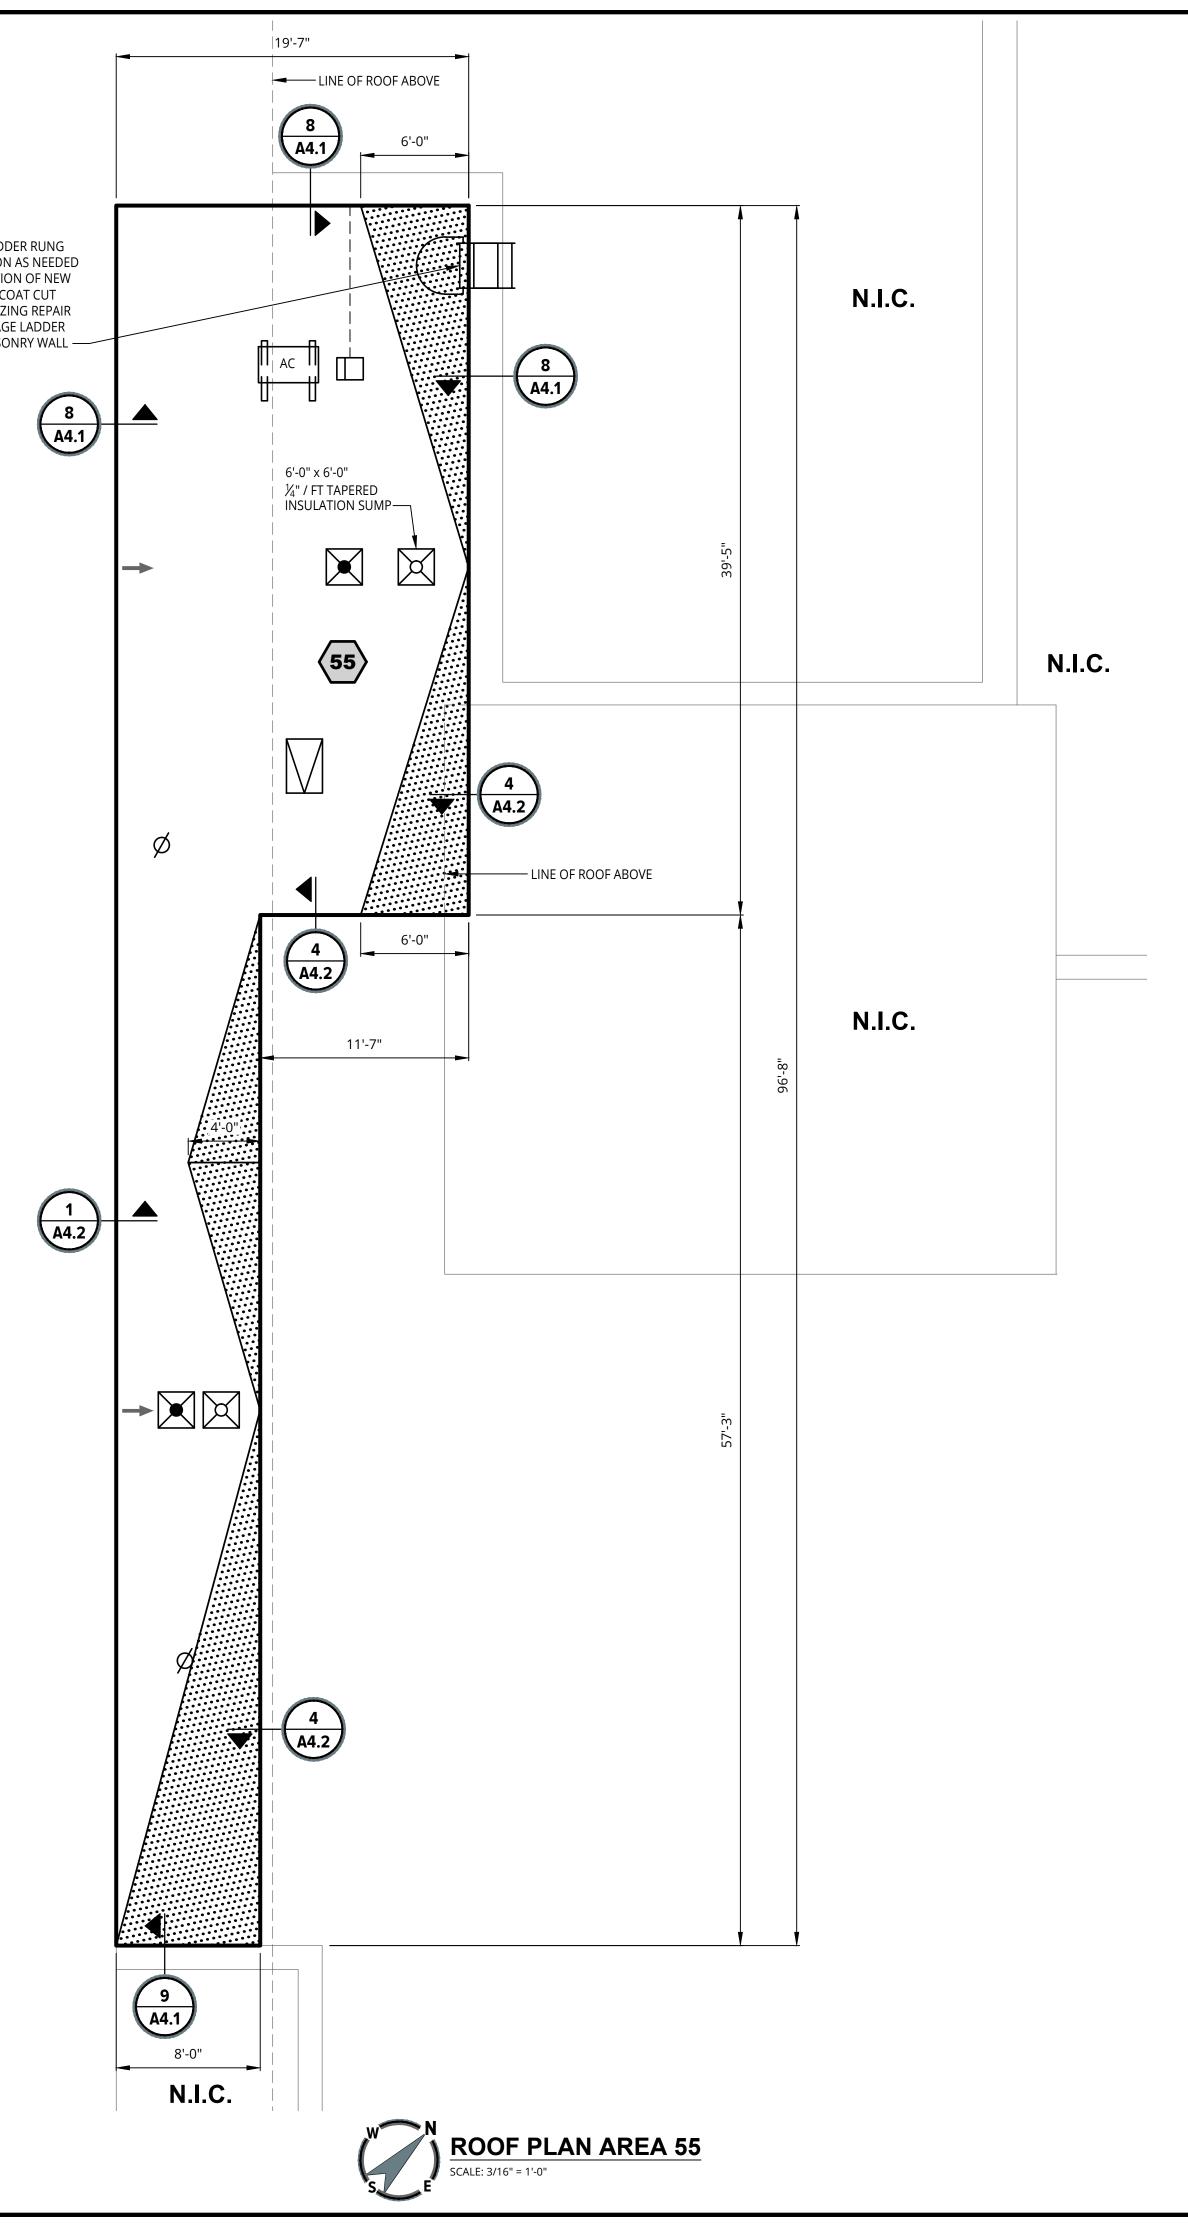


ROOF	AREA(S


55

ROOF ASSEMBLY (MEMBRANE TO DECK)

MEMBRANE: BLACK, 60-MIL, REINFORCED EPDM MEMBRANE AS SPECIFIED, FULLY ADHERED IN BONDING ADHESIVE COVER BOARD: 1/2" DENSDECK PRIME COVER BOARD, ADHERED IN LOW-RISE FOAM BASE INSULATION: 2 LAYERS OF 2.6" POLYISOCYANURATE INSULATION, ADHERED IN LOW-RISE FOAM VAPOR RETARDER: VAPOR RETARDER ADHERED IN PRIMER, AS SPECIFIED SUBSTRATE BOARD: 1/2" DENSDECK PRIME BOARD, MECHANICALLY ATTACHED

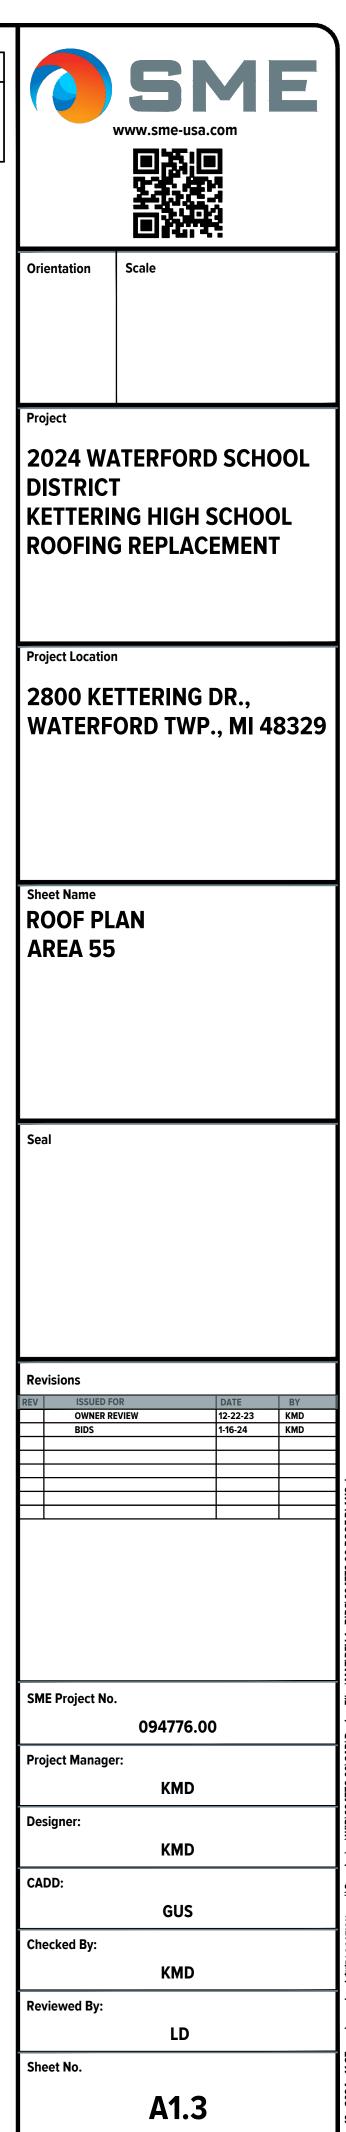


LEGEND

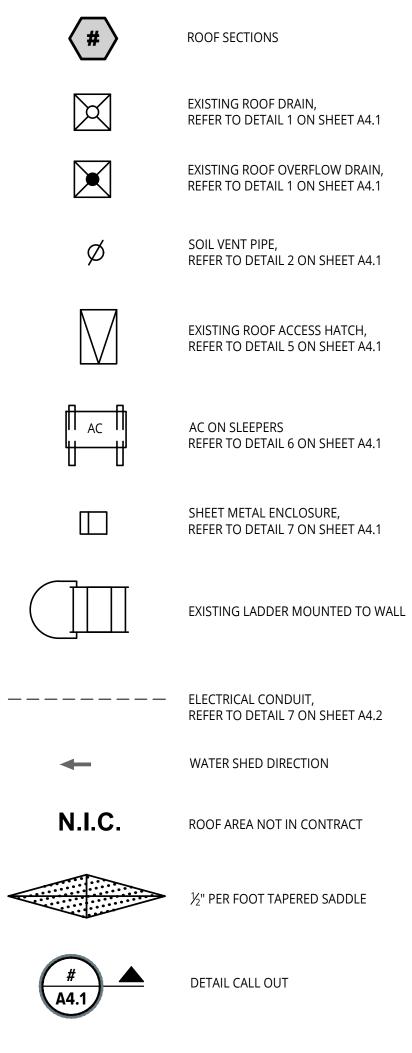



NOTES: 1. FIELD VERIFY ALL DIMENSIONS.

DRAWING NOTE: SCALE DEPICTED IS MEANT FOR 24" X 36" AND WILL SCALE INCORRECTLY IF PRINTED ON ANY OTHER SIZE MEDIA


NO REPRODUCTION SHALL BE MADE WITHOUT THE PRIOR CONSENT OF SME © 2023

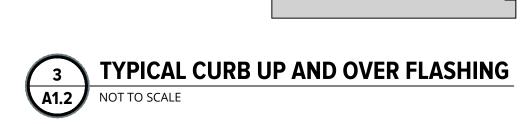


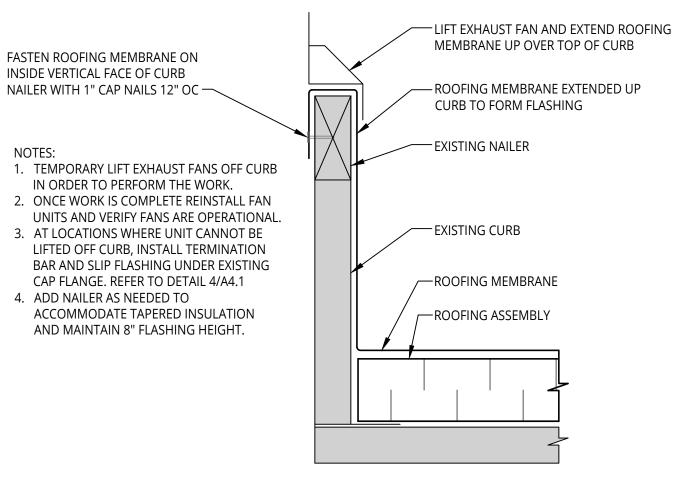

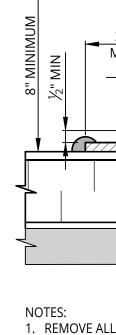




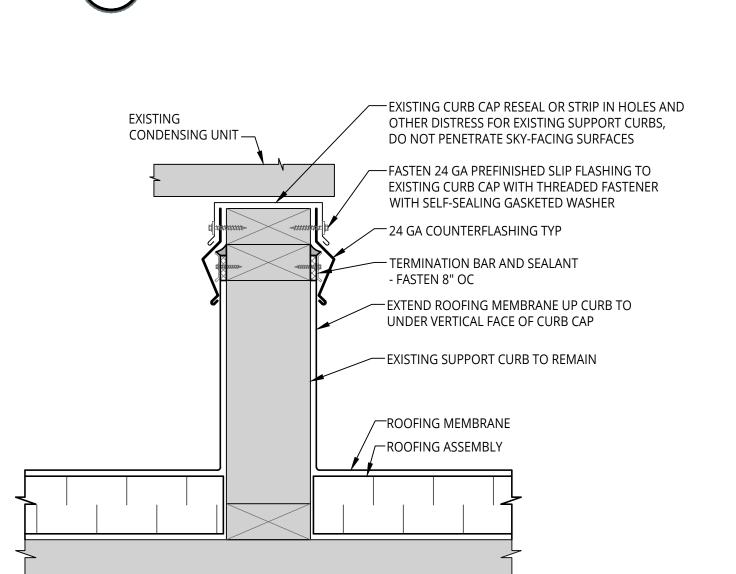


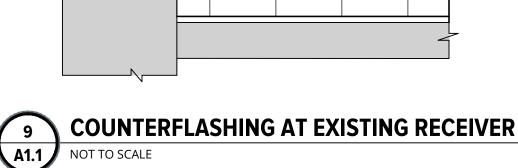

9

NOTES:

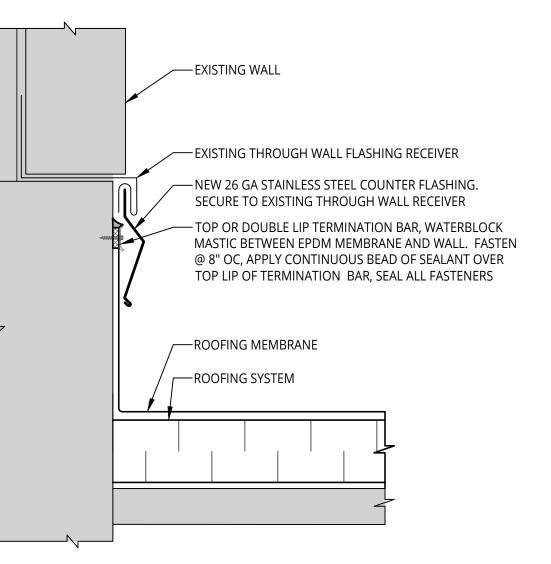

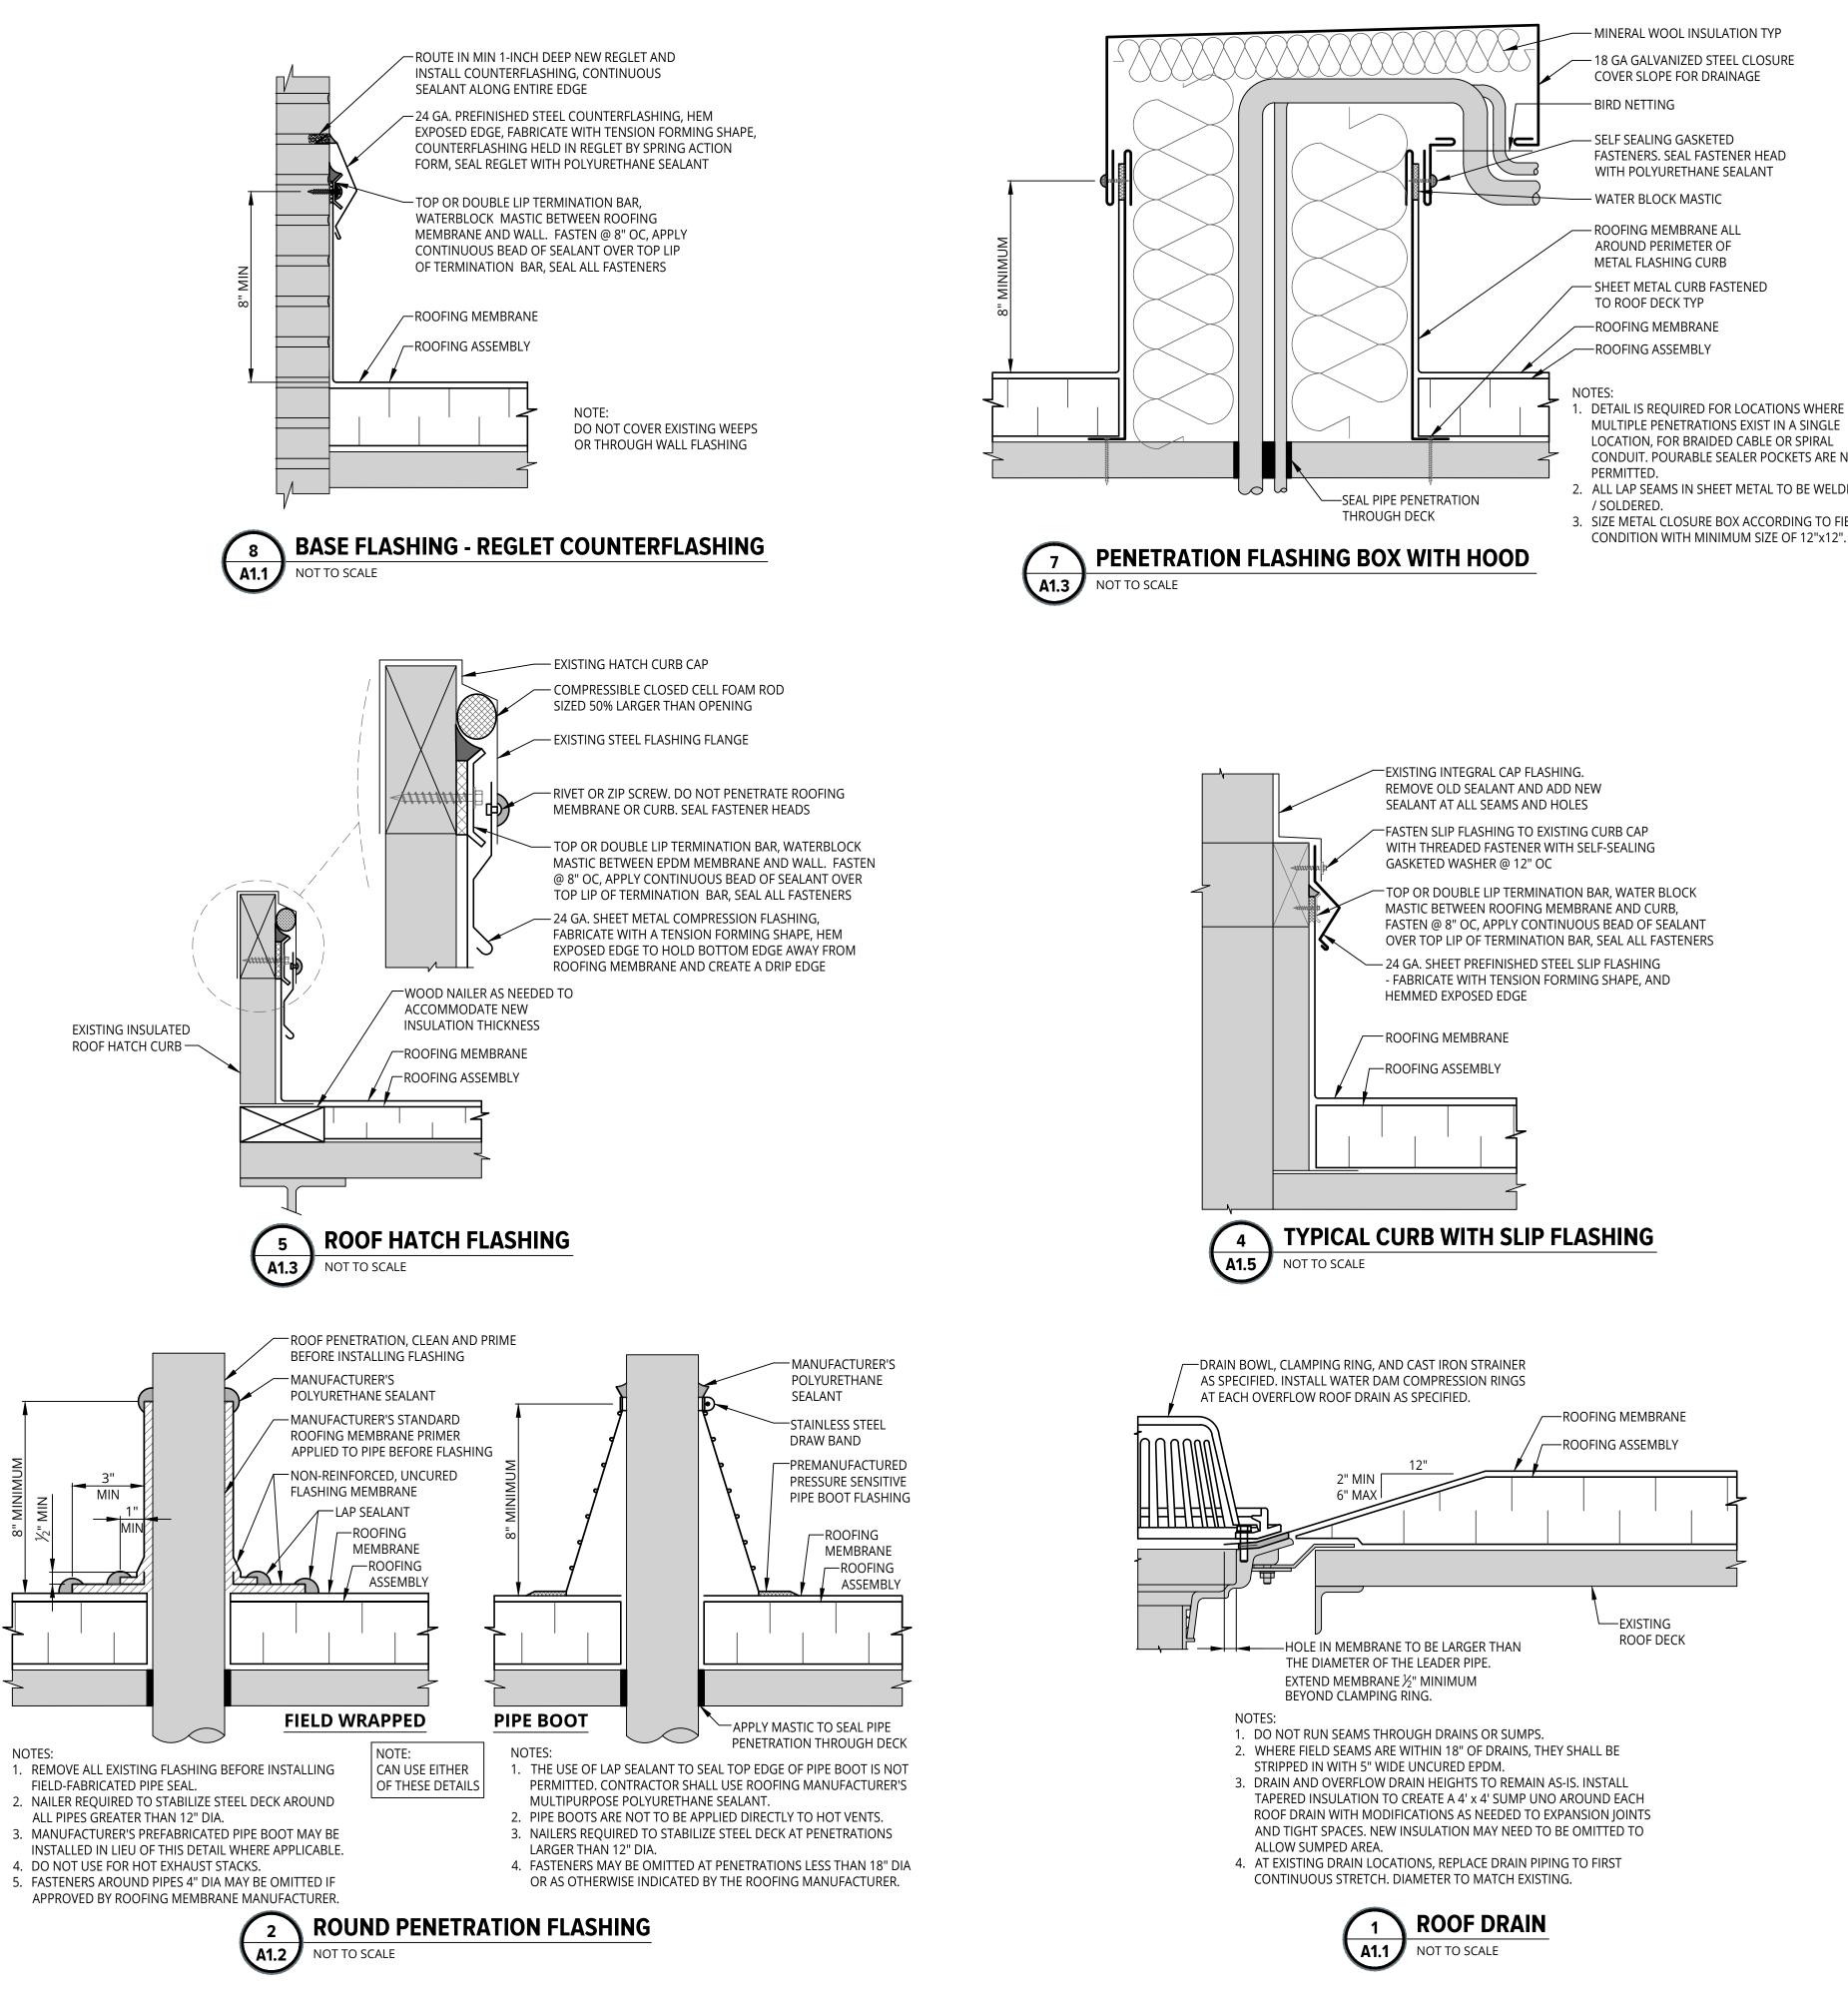

	ROOFING MEMBRANE
	24 GA. SHEET PREFINISHED STEEL SI - FABRICATE WITH TENSION FORMIN HEMMED EXPOSED EDGE
-nfun	TOP OR DOUBLE LIP TERMINATION MASTIC BETWEEN ROOFING MEMBF FASTEN @ 8" OC, APPLY CONTINUO OVER TOP LIP OF TERMINATION BAR
	FASTEN SLIP FLASHING TO EXISTING WITH THREADED FASTENER WITH SI GASKETED WASHER @ 12" OC
	EXISTING INTEGRAL CAP FLASHING. REMOVE OLD SEALANT AND ADD NI SEALANT AT ALL SEAMS AND HOLES

2. ALL LAP SEAMS IN SHEET METAL TO BE WELDED 3. SIZE METAL CLOSURE BOX ACCORDING TO FIELD

- 1. DETAIL IS REQUIRED FOR LOCATIONS WHERE MULTIPLE PENETRATIONS EXIST IN A SINGLE LOCATION, FOR BRAIDED CABLE OR SPIRAL CONDUIT. POURABLE SEALER POCKETS ARE NOT

- SHEET METAL CURB FASTENED
- FASTENERS. SEAL FASTENER HEAD WITH POLYURETHANE SEALANT
- COVER SLOPE FOR DRAINAGE
- MINERAL WOOL INSULATION TYP – 18 GA GALVANIZED STEEL CLOSURE

			5 R	com	E
Orie	ntation	Scale			
DI: KE	ect 24 W/ STRIC STRIC OFIN	T NG HI	GH S	5CHO	DL
28	ect Locatio 800 KE ATERF	TTER		•	8329
	et Name ASHIN	IG DE	TAIL	S	
Seal	I				
1					
Revi	sions				BY
Revi	ISSUED F OWNER F BIDS			DATE 12-22-23 1-16-24	KMD KMD
	ISSUED F			12-22-23	KMD
	ISSUED F			12-22-23	KMD
SME	ISSUED F OWNER F BIDS	2EVIEW	776.00	12-22-23 1-16-24	KMD
SME	ISSUED F OWNER F BIDS	2EVIEW	776.00	12-22-23 1-16-24	KMD
SME	ISSUED F OWNER F BIDS	2EVIEW 		12-22-23 1-16-24	KMD
SME	E Project No	xeview 	(MD	12-22-23 1-16-24	KMD
REV	E Project No	xeview 		12-22-23 1-16-24	KMD
REV	E Project No	xeview 	(MD GUS	12-22-23 1-16-24	KMD




THREADED FASTENER WITH PREFINISHED SNAP-ON FASCIA, SIZE TO BE (VIF) —

RIBBED PROFILE TO COMPRESS MEMBRANE ONTO WALL —

FASCIA METAL @ 8" OC

SELF ADHERING MEMBRANE -----

1½" LONG @ 8" OC

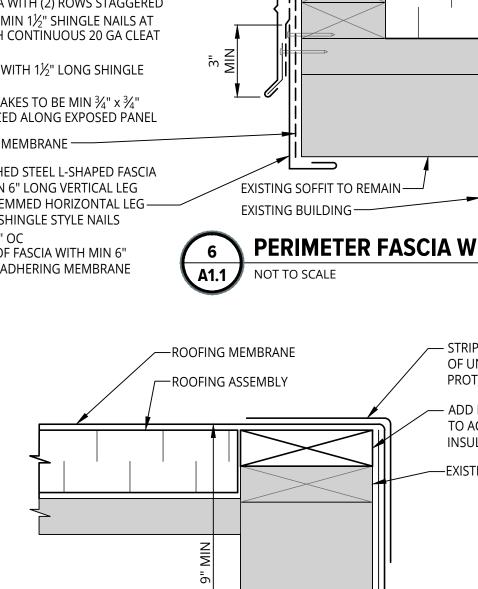

PERIMETER FASCIA WITH SOFFIT

- NEW PLYWOOD NAILER AS

NEEDED TO ACCOMMODATE

NEW INSULATION THICKNESSES

-ROOFING MEMBRANE

-ROOFING ASSEMBLY

-EXISTING NAILER(S) TO REMAIN,

REPLACE IF DETERIORATED

NAILERS ARE FOUND

– STRIP IN EDGE WITH MIN 12" STRIP OF UNCURED EPDM FOR ADDED PROTECTION FROM FOOT TRAFFIC - ADD NEW NAILER AS NEEDED TO ACCOMMODATE NEW INSULATION THICKNESSES -EXISTING WOOD NAILER(S)

ROOF TO ROOF TRANSITION 3 A1.1 NOT TO SCALE

SET CLEAT FLANGE IN BUTYL SEALANT AS REQUIRED BY EDGE METAL MANUFACTURER -----

EXTRUDED ALUMINUM CLEAT DO NOT FASTEN TOP HORIZONTAL FLANGE

THREADED FASTENER WITH SELF-SEALING GASKETED WASHER -----

PREFINISHED SNAP-ON

FASCIA, SIZE TO BE (VIF) -

RIBBED PROFILE TO COMPRESS MEMBRANE ONTO WALL-

REMOVE EXISTING EDGE METALS, FLASHINGS, AND MEMBRANES. INSTALL 22 GA PREFINISHED STEEL FASCIA METAL WITH HEMMED TOP EDGE,

2 STIFFENING BRAKES, AND DRIP EDGE ------ EXTEND NEW FASCIA METAL MIN 2" BEHIND

NEW FASCIA AND MIN 3" OVER NEW L-SHAPED FASCIA METAL

- SECURE FASCIA WITH (2) ROWS STAGGERED @ 8" OC WITH MIN 1½" SHINGLE NAILS AT

TOP AND WITH CONTINUOUS 20 GA CLEAT AT BOTTOM

- SECURE CLEAT WITH 1½" LONG SHINGLE NAILS @ 8" OC

- STIFFENING BRAKES TO BE MIN ³/₄" x ³/₄" EQUALLY SPACED ALONG EXPOSED PANEL

SELF ADHERING MEMBRANE -

24 GA PREFINISHED STEEL L-SHAPED FASCIA METAL WITH MIN 6" LONG VERTICAL LEG AND 2" LONG HEMMED HORIZONTAL LEG -- SECURE WITH SHINGLE STYLE NAILS

1½" LONG @ 8" OC - STRIP IN TOP OF FASCIA WITH MIN 6" STRIP OF SELF ADHERING MEMBRANE

